

Development Review Committee

1020 East Pioneer Road Draper, Utah 84020

STAFF REPORT

February 9, 2022

To: Jennifer Jastremsky, Zoning Administrator

Approved

Date

From:Maryann Pickering, AICP, Planner III
(801) 576-6391 or maryann.pickering@draperutah.gov

Re: Verizon Sal Sand Jump – Permitted Use Permit Request

Application No.:	USE-117-2021
Applicant:	Keleigh Glass of J5 Infrastructure
Project Location:	Approximately 15101 S. Minuteman Drive
Current Zoning:	M1 (Light Manufacturing) Zone
Acreage:	Approximately 3.88 acres (approximately 169,012 square feet)
Request:	Request for approval of a permitted use permit in the M1 zone
	regarding an existing wireless facility equipment upgrade.

SUMMARY AND BACKGROUND

This application is a request for approval of a permitted use permit for approximately 3.88 acres located on the east side of Minuteman Drive, at approximately 15101 S. Minuteman Drive (Exhibit B). The property is currently zoned M1. The parcel is owned by Box N Lock Storage Draper, LLC. Since the monopole has all necessary permits, and since no additional monopole height is being requested, this request may be approved at staff level and without a public hearing.

The subject monopole was approved by the Draper Planning Commission on August 28, 2014. The application was #140715-15101S. The monopole has been in continuous use since that approval.



<u>ANALYSIS</u>

<u>General Plan and Zoning</u>. The Land Use Map of the General Plan calls for the Community Commercial land use designation for the subject property (Exhibit C). This category is characterized as follows:

Community	Commercial
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LAND USE DESCRIPTIO	Ν
CHARACTERISTICS	 Includes the full scope of commercial land uses that require and utilize exposure to the freeway Intended to be traveler-or commuter-oriented and should provide lodging, food, personal services and other similar uses Frontage roads Deeper setbacks for landscaping and enhancements Limited traffic access points Visual unity Uniform design standards and aesthetics Access to individual properties should be provided only from frontage roads Well landscaped street frontages Limited traffic access points for the site Common off-street traffic circulation and parking areas Pedestrian access from surrounding residential areas
LAND USE MIX	Large-scale, master-planned commercial centersBig-box stores and offices
COMPATIBLE ZONING	 Community Commercial (CC) General Commercial (CG) Interchange Commercial (CI) Institutional Care (IC)
LOCATION	 Strategically placed along high-traffic corridors with convenient points of traffic access to and from residential areas

The property has been assigned the M1 zoning classification. The purpose of the M1 zone is to *"provide areas for uses involving processing and assembly of manufactured goods, warehousing, and material storage. Uses which generate excessive noise, vibration, odor, dust, and fumes are excluded from this zone."* The property is surrounded by CC (Community Commercial) zoning to the north, CR (Regional Commercial) to the east and Interstate 15 to the west. M1 zoning is located to the south.

<u>*Requested Modification*</u>. The applicant is proposing an upgrade to the existing equipment within the tower. The following is proposed:

• Remove six existing panel antennas at approximately 85'-0".



- Remove nine existing remote radio head (RRH) units at approximately 85'-0".
- Install three new panel antennas at approximately 85'-0".
- Install three new 5G L-Sub6 antennas at approximately 85'-0".
- Install six new remote radio head (RRH) units at approximately 85'-0".

There will be no changes to the height of the structure or ground space. The proposed plan set is included at Exhibit E.

<u>*Criteria for Approval.*</u> The criteria for review and potential approval of a permitted use request is found in Section 9-5-070(E) of the Draper City Municipal Code. This section depicts the standard of review for such requests as:

- E. Approval Standards: The following standards shall apply to the issuance of a permitted use permit. A permitted use shall:
 - 1. Be allowed as a permitted use in the applicable zone;
 - 2. Conform to development standards of the applicable zone;
 - 3. Conform to applicable regulations of general applicability and regulations for specific uses set forth in this title;
 - 4. Not be located on any land classified as a primary or secondary conservation area or sensitive land area, except as expressly permitted by provisions of this title;
 - 5. Not be located in any protected area as shown on a natural resource inventory; and
 - 6. Conform to any other applicable requirements of this code.

<u>REVIEWS</u>

<u>Planning Division Review</u>. The Draper City Planning Division has completed their review of the Permitted Use Permit submission. Comments from this division, if any, can be found in Exhibit A.

<u>Engineering and Public Works Divisions Review</u>. The Draper City Engineering and Public Works Divisions have completed their reviews of the Permitted Use Permit submission. Comments from these divisions, if any, can be found in Exhibit A.

Fire Division Review. The Draper City Fire Marshal has completed his review of the Permitted Use Permit submission. Comments from this division, if any, can be found in Exhibit A.

Noticing. Notice has been properly issued in the manner outlined in the City and State Codes.



STAFF RECOMMENDATION

Staff finds that the application complies with the DCMC and recommends that the Zoning Administrator review the request and approve the application based on the findings listed below and the criteria for approval, as listed within the staff report.

If the Zoning Administrator decides to approve the request, staff recommends they include the following conditions of approval:

- 1. That the proposed changes will have no perceptible visual impact.
- 2. That the proposed changes are compliant with Section 9-41-050(E) of the DCMC.
- 3. The applicant shall obtain all applicable permits from Draper City Fire and the Building Division for this upgrade.



DEVELOPMENT REVIEW COMMITTEE ACKNOWLEDGEMENT

We, the undersigned, as duly appointed members of the Draper City Development Review Committee, do acknowledge that the application which provides the subject for this staff report has been reviewed by the Committee and has been found to be appropriate for review by the Draper City Planning Commission and/or City Council.

Draper City Public Works Department

Draper City Planning Division

Draper City Fire Department

Draper City Legal Counsel

Draper City Building Division



EXHIBIT A DEPARTMENT REVIEWS

REVIEWS ARE NOT MEANT TO BE AN ALL INCLUSIVE LIST OF POSSIBLE COMMENTS OR CONDITIONS.

Planning Division Review

No additional comments provided.

Engineering and Public Works Divisions Review.

No additional comments provided.

<u>Fire Division Review</u>.

- 2A-10BC Fire Extinguishers required. The extinguisher needs to be a serviceable type meaning metal head and metal neck. Extinguishers need to be located in a conspicuous location where they will be readily accessible and immediately available for use. Placed on every level of the home. If in cabinet or not the extinguisher or cabinet needs to be mounted so that the top is not more than five (5) feet above the floor.
- 2. Fire Department Access is required to be maintained. Vehicles cannot park in such a way to impede fire department or emergency vehicle access.
- 3. Hazardous Material Permit A Draper City Fire Hazardous Material Permit may need to be obtained. This is for all new and existing installations.

EXHIBIT B AERIAL MAP

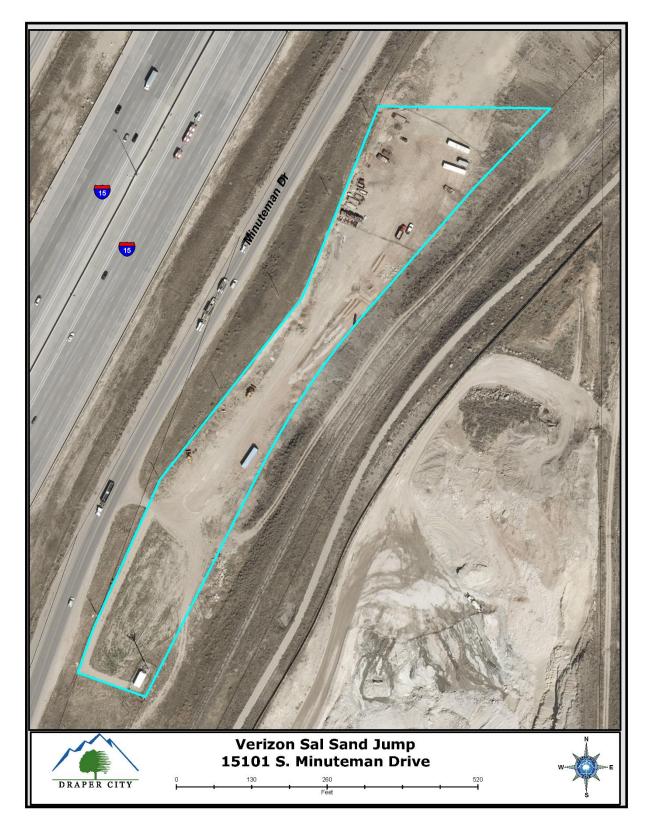


EXHIBIT C LAND USE MAP

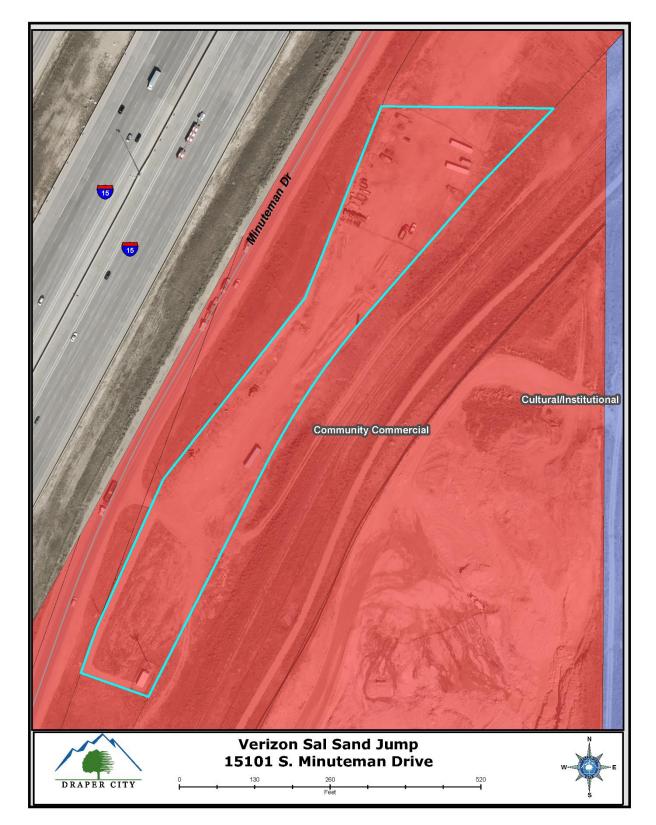


EXHIBIT D ZONING MAP

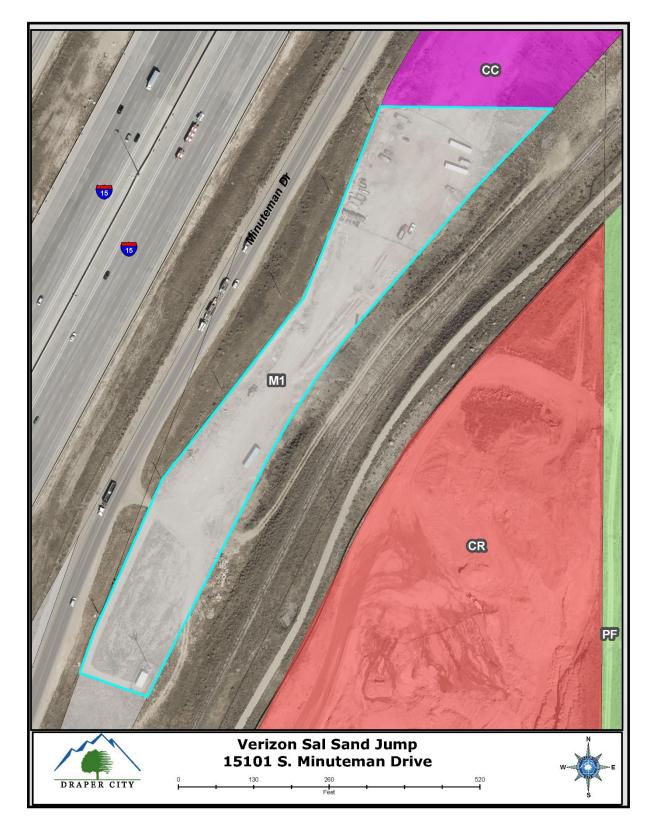


EXHIBIT E PROPOSED PLANS

EVICTINO	FOUIDMENT	/EACENENT	
EXISTING	EQUIPMENT	/EASEMENT	

ACCESS EASEMENT

UTILITY FASEMENT

FASE AREA

CONTRACTOR PMI REC	QUIREMENTS:
PMI ACCESS:	http://pmi.vzwsmart.com
SMART TOOL PROJECT NUMBER:	10017146
VZW LOCATION CODE: (PLSC):	266111

Verizonv SAL SAND JUMP

15101 S MINUTEMAN DR DRAPER, UTAH 84020 SALT LAKE COUNTY

EXISTING COMMUNICATION SITE C-BAND INSTALLATION PROJECT

SHEET INDEX:

SHEET	TITLE	REV.
T1	TITLE SHEET	0
SP1	SPECIFICATION & PHOTO SHEET	0
C1	SITE PLAN	0
C2	ELEVATIONS	0
С3	SHELTER MAPPING & RRH CABLE CHART	0
C4	SECTIONS & DETAILS	0
C5	WIRING DIAGRAM	0
RF1	ANTENNA INFORMATION	0
RF2	RFDS ANTENNA SUMMARY	0
RF3	RFDS PLUMBING DIAGRAM	0

	PRO	JECT	INDE)	<u> </u>	
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		ACT: ALY: E: 801-			
	5225	<u>AQ:</u> IFRASTRU WILEY P LAKE CI ⁻	OST WA	Y, SUIT	E 410
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	FOR AND	FACILITY HUMAN H EXITS SH CABLE B	ABITATIC)N. LA MPLY W	NDINGS /ITH AL

GENERAL PROJECT NOTES: PRIOR TO SUBMITTING A BID, THE CONTRACTOR SHALL FAMILIARIZE HIMSELF/HERSELF WITH THE SCOPE OF WORK AND ALL CONDITIONS AFFECTING THE NEW PROJECT. CONTRACTOR SHALL VERIFY ALL FIELD CONDITIONS AND DIMENSIONS OF THE JOB SITE AND CONFIRM THAT WORK AS INDICATED ON THESE CONSTRUCTION DOCUMENTS CAN BE ACCOMPLISHED AS SHOWN PRIOR TO COMMENCEMENT OF ANY WORK ALL FIELD MODIFICATIONS BEFORE, DURING, OR AFTER CONSTRUCTION SHALL BE APPROVED IN WRITING BY A VERIZON REPRESENTATIVE INSTALL ALL EQUIPMENT AND MATERIALS PER THE MANUFACTURER'S RECOMMENDATIONS, U.N.O. NOTIFY VERIZON, IN WRITING, OF ANY MAJOR DISCREPANCIES REGARDING THE CONTRACT DOCUMENTS, EXISTING CONDITIONS, AND DESIGN INTENT. THE CONTRACTOR SHALL BE RESPONSIBLE FOR OBTAINING CLARIFICATIONS FROM A VERIZON REPRESENTATIVE AND ADJUSTING THE BID ACCORDINGLY. CONTRACTOR SHALL BE SOLELY RESPONSIBLE FOR ALL CONSTRUCTION MEANS, METHODS, TECHNIQUES, SEQUENCES, AND PROCEDURES OF THE WORK UNDER THE CONTRACT. CONTRACTOR SHALL PROTECT ALL EXISTING IMPROVEMENTS AND FINISHES THAT ARE TO REMAIN. CONTRACTOR SHALL NOT REPAIR ANY DAMAGE THAT MAY OCCUR DURING THE CONSTRUCTION TO THE SATISFACTION OF A VERIZON REPRESENTATIVE. THE CONTRACTOR IS RESPONSIBLE FOR RED-LINING THE CONSTRUCTION PLANS TO ILLUSTRATE THE AS BUILT CONDITION OF THE SITE. FOLLOWING THE FINAL INSPECTION BY VERIZON, THE CONTRACTOR SHALL PROVIDE VERIZON WITH ONE COPY OF ALL RED-LINED DRAWINGS. VERIFY ALL FINAL EQUIPMENT WITH A VERIZON REPRESENTATIVE. ALL EQUIPMENT LAYOUT, SPECS PERFORMANCE INSTALLATION AND THEIR FINAL LOCATION ARE TO BE APPROVED BY VERIZON. THE CONTRACTOR SHALL BE RESPONSIBLE FOR COORDINATING HIS/HER WORK WITH THE WORK AND CLEARANCES REQUIRED BY OTHERS RELATED TO

SAID INSTALLATIONS.


<u> PROJECT INFORMATIO</u>	<u>N:</u>
ROPERTY OWNER:	BOX N LOCK STORAGE DRAPER 15101 S MINUTEMAN DR DRAPER, UT 84020
URISDICTION:	DRAPER, UT 1020 E PIONEER RD PHONE: 801-571-6535
UBLIC RECORD PARCEL NO:	33131000180000
CCUPANCY CLASSIFICATION:	U - UTILITY & MISC.
YPE OF CONSTRUCTION:	TYPE II-B


DRIVING DIRECTIONS:

40°28'32.8188"N LATITUDE: LONGITUDE: 111'54'13.4712"W

FROM THE VERIZON OFFICE LOCATED AT 9656 S PROSPERITY ROAD IN WEST JORDAN: HEAD SOUTH ON PROSPERITY ROAD (0.7 MI), TURN LEFT ONTO 10200 S (0.4 MI), TURN RIGHT ONTO UT-85 (4.5 MI), TURN LEFT ONTO 13400 S (1.1 MI) TURN RIGHT ONTO BANGERTER HWY (5.2 MI), USE THE RIGHT LANE TO MERGE ONTO I-15 S (1.3 MI), USE THE 2ND FROM THE RIGHT LANE TO TAKE EXIT 288 FOR UT-140 TOWARD 14600 S (0.2 MI), KEEP LEFT AT THE FORK (463 FT), CONTINUE STRAIGHT ONTO UT-140 E (0.2 MI), TURN RIGHT ONTO MINUTEMAN DR (0.6 MI) TURN LEFT (40 FT), TURN RIGHT (0.1 MI), TURN LEFT (100 FT), DESTINATION WILL BE STRAIGHT AHEAD.




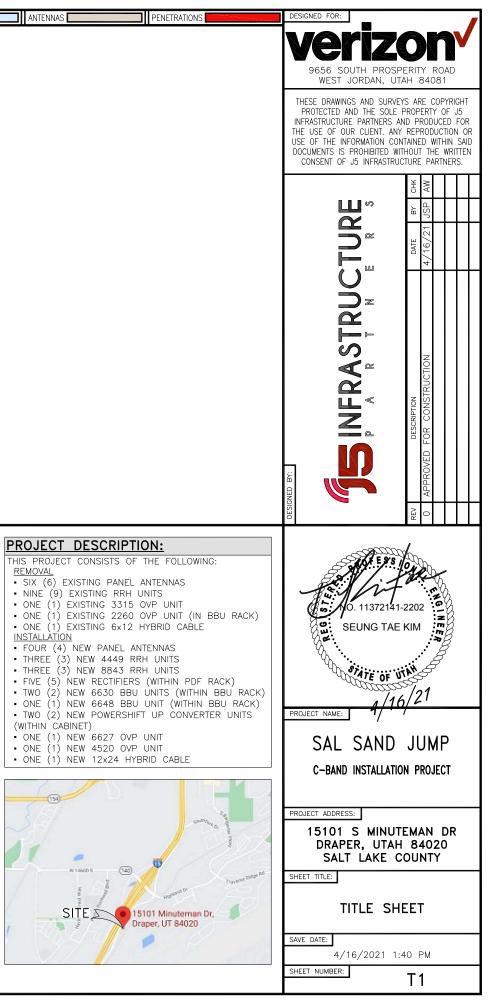


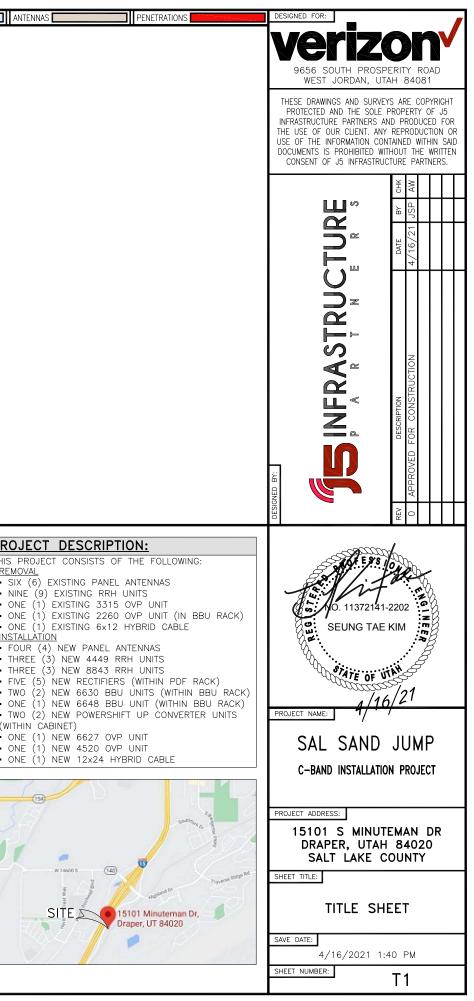


EXISTING EQUIPMENT/EASEMENT	LEASE AREA	HYBRID/COAX
GENERAL PROJECT NOTES:	COAX PORT NOTES:	LEGEND OF SYMBOLS:
1. CONTRACTOR IS RESPONSIBLE FOR ERECTING TEMPORARY BARRICADES AND/OR FENCING TO PROTECT THE SAFETY OF THE PUBLIC DURING CONSTRUCTION. THE CONTRACTOR SHALL REMOVE ALL TEMPORARY BARRIERS AND REPAIR ALL DAMAGE TO PROPERTY ON THE SITE CAUSED BY THIS CONSTRUCTION. THE COST OF REPAIR IS THE CONTRACTOR'S RESPONSIBILITY.	REQUIRED ADDITIONAL COAX PORTS TO BE ADDED AS NEEDED BY CONTRACTOR. ANY ADDITIONAL COAX PORTS TO BE INSTALLED BELOW THE EXISTING, WHERE PO CONTRACTOR TO INVESTIGATE INTERIOR OF SHELTER/EQUIPMENT ROOM FOR CLEAP PENETRATION POINT.	REST OR NUMBER
 ALL WORK SHALL BE IN ACCORDANCE WITH APPLICABLE LOCAL, STATE, AND FEDERAL REQUIREMENTS. THE CONTRACTOR SHALL BE RESPONSIBLE FOR VERIFICATION OF ALL MEASUREMENTS AT THE SITE PRIOR TO ORDERING ANY MATERIALS OR CONDUCTING ANY WORK. EXCESS SOIL MATERIAL AND DEBRIS CAUSED BY THIS CONSTRUCTION SHALL BE REMOVED FROM THE SITE AND DISPOSED OF IN A LEGAL MANNER. CONTRACTOR SHALL MAKE ADJUSTMENTS TO GRADING ELEVATIONS AS NECESSARY TO ENSURE A SITE FREE OF DRAINAGE PROBLEMS. 	4. ADDITIONAL COAX PORTS TO BE INSTALLED PER INDUSTRY STANDARDS.	SHEET WHERE DRAWN SHEET WHERE TAKEN SECTION LETTER SECTION LETTER SHEET WHERE DRAWN
 6. CONTRACTOR SHALL COORDINATE A CONSTRUCTION LAYDOWN AREA WITH THE PROPERTY OWNER. CONSTRUCTION LAYDOWN AREA SHALL BE FENCED-IN WITH TEMPORARY (45 DAY) CONSTRUCTION FENCE. THE TEMPORARY FENCE SHALL BE CONSTRUCTED OF 6' HIGH CHAIN LINK FABRIC AND IS TO BE REMOVED AT THE END OF CONSTRUCTION. LAYDOWN AREA IS TO BE RESTORED TO ITS ORIGINAL CONDITION AFTER FENCE REMOVAL. 7. SURVEY INFORMATION SHOWN WAS CREATED FROM RECORD INFORMATION AND DOES NOT CONSTITUTE A LEGAL BOUNDARY SURVEY. 8. THESE PLANS DO NOT ADDRESS THE SAFETY AND STABILITY OF THE STRUCTURE DURING ASSEMBLY AND ERECTION, WHICH ARE THE RESPONSIBILITY OF THE ERECTOR. 	-(6) EXISTING VERIZON PANEL ANTENNAS	CENTERLINE
BASED ON THE MEANS AND METHODS CHOSEN BY THE ERECTOR.		d PENNY
GENERAL CONTRACTOR NOTES: 1. THE CONTRACTOR SHALL BE RESPONSIBLE FOR THE COMPLETE PROJECT SCOPE OF WORK DEFINED UNDER THE REQUEST FOR PROPOSAL (RFP) FOR THIS PROJECT AND ALL ASSOCIATED ATTACHMENTS AND DOCUMENTS PROVIDED. THE RFP AND ALL ASSOCIATED DOCUMENTS SHALL DEFINE THE COMPLETE PROJECT SCOPE OF WORK. CONTRACTOR SHALL BE RESPONSIBLE FOR COMPLIANCE WITH ALL DOCUMENTS AND IS SOLELY RESPONSIBLE FOR ALL WORK. ALL DOCUMENTS INCLUDED WITHIN THE PROJECT REQUEST FOR PROPOSAL ARE REQUIRED FOR THE COMPLETE PROJECT SCOPE OF WORK. THE CONTRACTOR SHALL BE RESPONSIBLE FOR ALL WORK (EQUIPMENT, MATERIAL, INSTALLATION, TESTING, ETC.) INDICATED IN ALL DOCUMENTS. THE RFP, VERIZON NETWORK STANDARDS AND PROJECT ADDENDUMS AND CLARIFICATIONS ANE COMPLEMENTARY TO EACH OTHER. THE FORMAT OF THE SPECIFICATIONS AND DRAWING NUMBERING PER DISCIPLINE IS NOT INTENDED TO IMPLY SEGREGATION OF SUB CONTRACTOR WORK. CONTRACTOR SHALL ASSIGN ALL SUB CONTRACTOR WORK AND VERIZON WILL NOT ACCEPT ANY CHANGE ORDERS FOR INTERNAL CONTRACTOR WORK AND VERIZON WILL NOT ACCEPT ANY CHANGE ORDERS FOR INTERNAL CONTRACTOR WORK ASSIGNMENTS. CONTRACTOR SHALL BE RESPONSIBLE FOR DISTRIBUTING ALL RFP DOCUMENTS TO THEIR SUB CONTRACTORS. ALL RFP DOCUMENTS ARE REQUIRED TO INDICATE THE PROJECT SCOPE OF WORK. PARTIAL SUB CONTRACTOR DOCUMENT PACKAGES ARE HIGHLY DISCOURAGED. IN THE EVENT OF A CONFLICT BETWEEN THE DRAWINGS, SPECIFICATIONS, REFERENCED STANDARDS, VERIZON STANDARDS, OR AGREEMENT TERMS AND CONDITIONS THE ARCHITECT/ ENGINEER SHALL BE CONTACTED FOR FORMAL INTERPRETATION OF THE	VIEW OF EXISTING ANTENNAS	
 REQUIREMÉNTS. THE CONTRACTOR SHALL BE DEEMED TO HAVE PROVIDED THE DETAILED AND EXTENSIVE INTERPRETATION. ANY WORK INSTALLED IN CONFLICT WITH THE ARCHITECT/ ENGINEER INTERPRETATIONS SHALL BE CORRECTED BY THE CONTRACTOR AT NO EXPENSE TO VERIZON. ALL ANTENNAS MUST BE PIM TESTED WITHIN 48 HOURS OF THEM BEING RECEIVED BY THE INSTALLATION CONTRACTOR. THOSE RESULTS MUST BE SENT BACK TO THE VERIZON CONSTRUCTION ENGINEER AND EQUIPMENT ENGINEER WITHIN THE SAME 48 HOURS. IF YOU MISS THE 48HR TIMELINE AND THE ANTENNAS DO NOT PASS UPON INSTALLATION, YOUR COMPANY WILL BE CHARGED FOR THE COST OF THE ANTENNAS FOR REPLACEMENT. ALL LOADS MUST BE SECURED PROPERLY TO THE VEHICLE OR TRAILER. VERIZON WILL PASS ALONG THE COST OF ANY REPLACEMENTS DUE TO DAMAGE OR LOSS WHETHER IT IS NEW OR USED. 		
 ANTENNA, MOUNTS & HARDWARE INSTALLATION NOTES: CONTRACTOR TO INSTALL ANTENNAS, MOUNTS AND TOWER HARDWARE PER MANUFACTURER'S RECOMMENDATIONS (OR AS REQUIRED BY THE OWNER/PROVIDER). ALL BOLTS SHALL BE TIGHTENED PER AISC REQUIREMENTS. ANY GALVANIZED SURFACES THAT ARE DAMAGED BY ABRASIONS, CUTS, DRILLING OR FIELD WELDING DURING SHIPPING OR ERECTION SHALL BE TOUCHED-UP WITH TWO COATS OF COLD GALVANIZING COMPOUND MEETING THE REQUIREMENTS OF ASTM A780. ANTENNA MOUNTS SHALL NOT BE USED AS A CLIMBING DEVICE. WORKERS SHALL ALWAYS TIE OFF TO AN APPROVED CLIMBING POINT. SEE ALSO GENERAL ANTENNA NOTES ON SHEET RF1 (IF APPLICABLE). MAIN OVP, SECTOR BOX, RRH, TMA, & DIPLEXER INSTALLATION NOTES: I. CONTRACTOR TO INSTALL MAIN OVP, SECTOR BOXES, REMOTE RADIO HEADS, TOWER MOUNTED AMPLIFIERS, AND/OR DIPLEXERS PER MANUFACTURER'S RECOMMENDATIONS. 		
 ALL BOLTS SHALL BE TIGHTENED PER AISC REQUIREMENTS. ANY GALVANIZED SURFACES THAT ARE DAMAGED BY ABRASIONS, CUTS, DRILLING OR FIELD WELDING DURING SHIPPING OR ERECTION SHALL BE TOUCHED-UP WITH TWO COATS OF COLD GALVANIZING COMPOUND MEETING THE REQUIREMENTS OF ASTM A780. 	VIEW OF EXISTING COAX PORT	VIEW OF EXISTING (LOOKING SOUTH



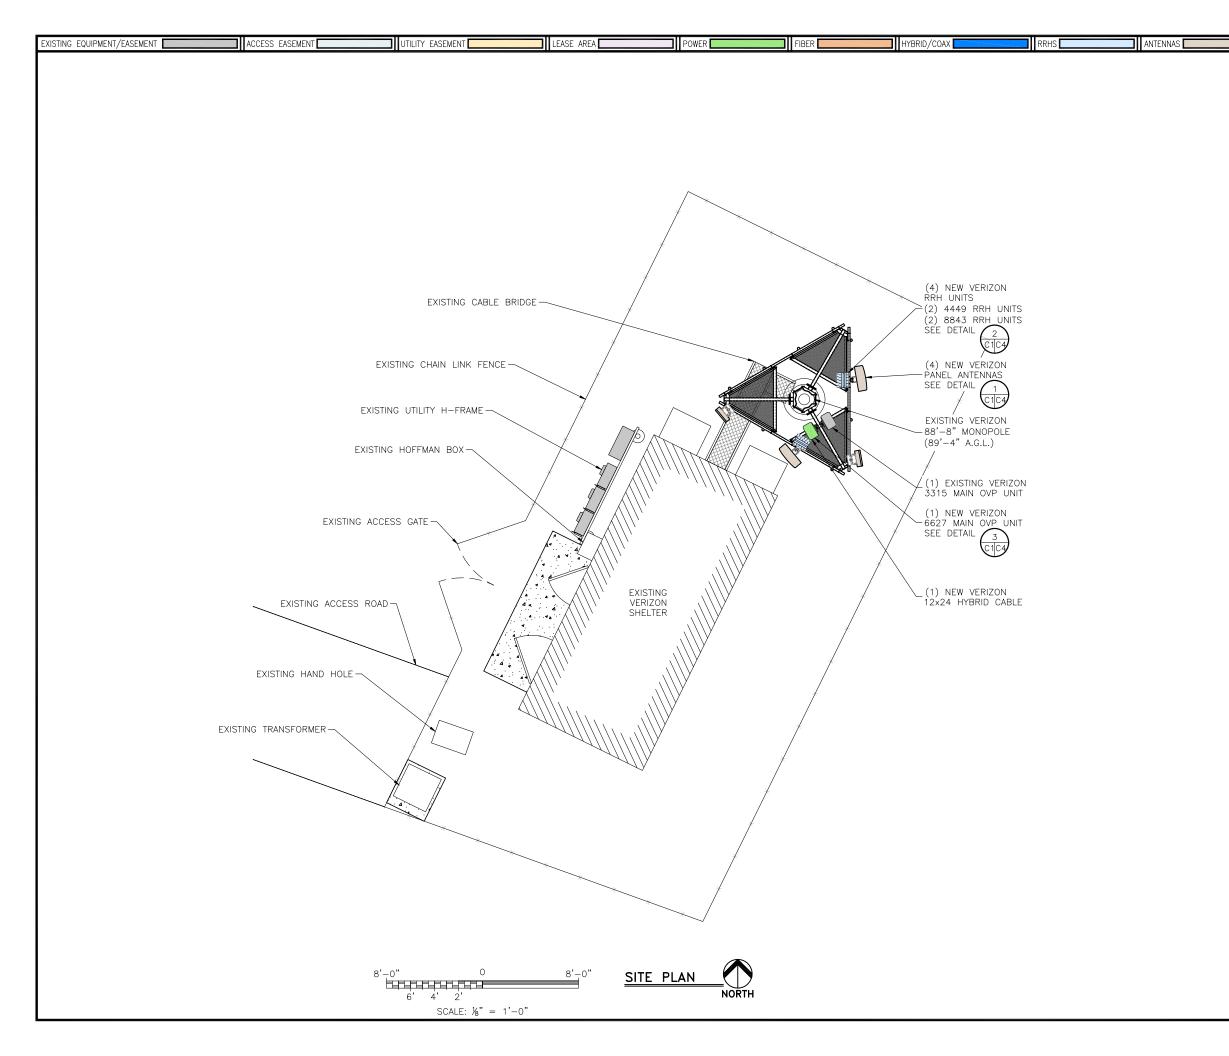


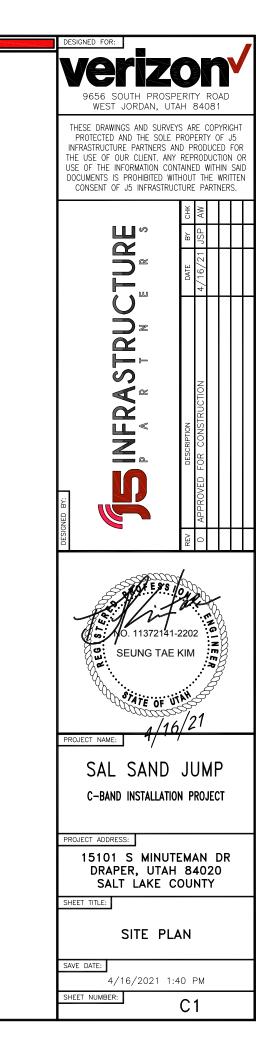

PENETRATIONS

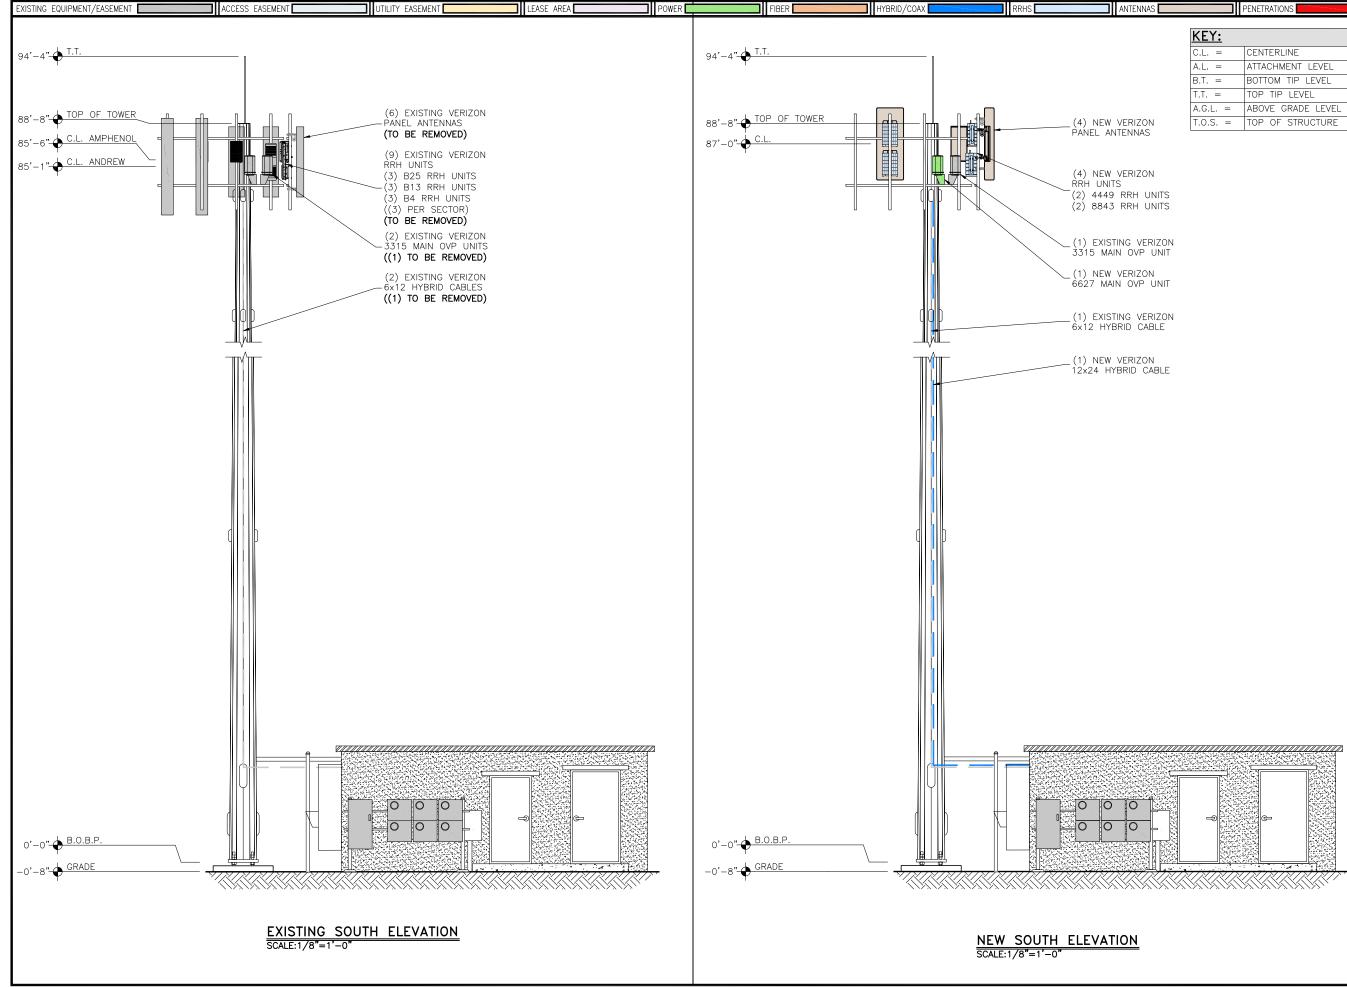

ESIGNED FOR:

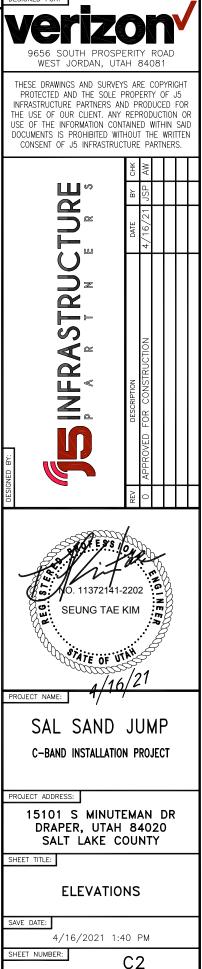


	1 f	0'-2" (INTERIO	२)	
ERIOR) 4'-0"				
15'-8" (INTERIOR)				
10 [°] 9 [°] 3 [°] -5 [°]				a. 3'-7"
<u>, , , , , , , , , , , , , , , , , , , </u>	2'-6"	4'-1" <u>3"</u>	7" 2'	-4"

ACCESS EASEMENT

UTILITY EASEMENT

EXISTING EQUIPMENT/EASEMENT 📘

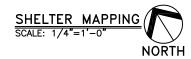

<u>KE</u>	<u>YED NOTES:</u>
9	HVAC
	BATTERY RACK
\bigcirc	COAX PORT
D	ACCESS DOOR
E	INTEGRATED LOAD CENTER
F	TELCO BOARD
6	SAFETY BOARD
(H)	DC POWER DISTRIBUTION CENTER
J	TEMPERATURE CONTROL
K	FIRE EXTINGUISHER
	AUTOMATIC TRANSFER SWITCH
(M)	A/C PANEL
\mathbb{N}	DEHYDRATOR
P	FIBER/OVP/BBU RACK
R	VENT
1	CRAN RACK
\bigcirc	ONE FIBER 23" RACK

POWER INFORMATION:

BATTERIES:

PDF RACK).

OVP UNIT (IN BBU RACK).

3. REPLACE (1) EXISTING 2260 OVP WITH (1) NEW 4520

4. INSTALL (2) NEW POWERSHIFT UP CONVERTERS (IN

POWER

FIBER

HYBRID/COAX


LEASE AREA

FROM (OVP) TO (C-BAND ANTENNAS) CABLE/COAX C-BAND ANTENNA JUMPERS CABLE/COAX (QUANTITY) SECTOR SIZE (NOMINAL) BETA HYB 1X1 (1) NEW GAMMA HYB 1X1 (1) NEW FROM (RRH) TO (ANTENNAS) CABLE/COAX SIZE (NOMINAL) LTE ANTENNA JUMPERS SECTOR CABLE/COAX (QUANTITY) BETA (12) NEW ½"ø GAMMA ½"ø (12) NEW FROM (MOVP) TO (RRH) CABLE/COAX SIZE (NOMINAL) CABLE/COAX (QUANTITY) RS SECTOR A P H BETA HYB 1X1 (2) NEW 3 GAMMA HYB 1X1 (2) NEW FROM (MOVP) TO (MOVP) CABLE/COAX CABLE/COAX (QUANTITY) SECTOR MAIN SIZE (NOMINAL) (1) EXISTING HYB 6X12 _ HYB 12X24 (1) NEW _

RRHS


NEW HYBRID CABLE LENGTHS:


TYPE: POWERSAFE ENERSYS	
MODEL #: DDMP85-15	
QUANTITY: 48 PDF:	-
PDF:	
TYPE: GE	
MODEL #: H5692448 G104	_
RECTIFIERS:	
TYPE: GE	
MODEL #: NE050AC48ATEZ QUANTITY: 4	
CONVERTERS:	-
TYPE: GE MODEL #: NE075DC24A	
QUANTITY: 2	
GENERATOR:] ((C
TYPE: GENERAC	
MODEL #: 0062900	
TANK: 210 GALLONS SIZE: 48KW	
	- (
PROJECT NOTES:	
1. INSTALL (5) 48V, 50A RECTIFIERS (IN PDF RACK).	
2. INSTALL (2) NEW BBU 6630 UNITS AND (1) NEW BBU	
6648 UNIT (WITHIN BBU RACK).	↓

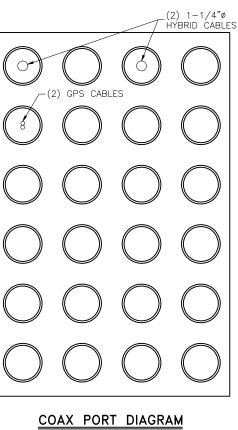





COAX (QUANTITY) CABLE/COAX LENGTH (1) NEW 10' (2) NEW CUT TO FIT (2) NEW COAX (QUANTITY) CABLE/COAX LENGTH CABLE/COAX LENGTH (2) NEW CUT TO FIT (2) NEW 10'	ANTENNAS		DESIGNED FOR:
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COMAR (QUANITITY) CAREE / SDAW (1) NEW 10' DENOTTING - 4.120' - 4.120' DENOTING CAREE / SDAW - 4.120' DENOTING CAREE / SDAW </td <td></td> <td></td> <td>Verizony</td>			Verizony
COMAR (QUANITITY) CAREE / SDAW (1) NEW 10' DENOTTING - 4.120' - 4.120' DENOTING CAREE / SDAW - 4.120' DENOTING CAREE / SDAW </td <td></td> <td></td> <td></td>			
COAX (QUANTITY) CABLE/COAX (1) NEW 10" (1) NEW 0.0" (2) NEW 0.0" <			
COUNT (UNITY) LENGTH (1) NEW 10' (12) NEW CUT TO FIT (12) NEW 10' (11) NEW 10' (12) NEW 10' (13) NEW 10' (14) NEW 10' (15) NEW 10' (12) NEW 10' (12) NEW 10' (13) NEW 10' (14) NEW 10' (15) NEW 10' (16) NEW 10' (17) NEW 10' (16) NEW 10' (17) <t< td=""><td></td><td></td><td></td></t<>			
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DRAPER, UTAH 84020 SALT LAKE COUNTY SHEET TITLE: SHELTER MAPPING & RRH CABLE CHART PHOTO OF EXISTING COAX PORT SAVE DATE: 4/16/2021 1:40 PM SHEET NUMBER			PROJECT ADDRESS:
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4/16/2021 1:40 PM			SAVE DATE:
SHEET NUMPER	EXISTING	COAX POR	
C3			CHEET NIIMPED
			C3

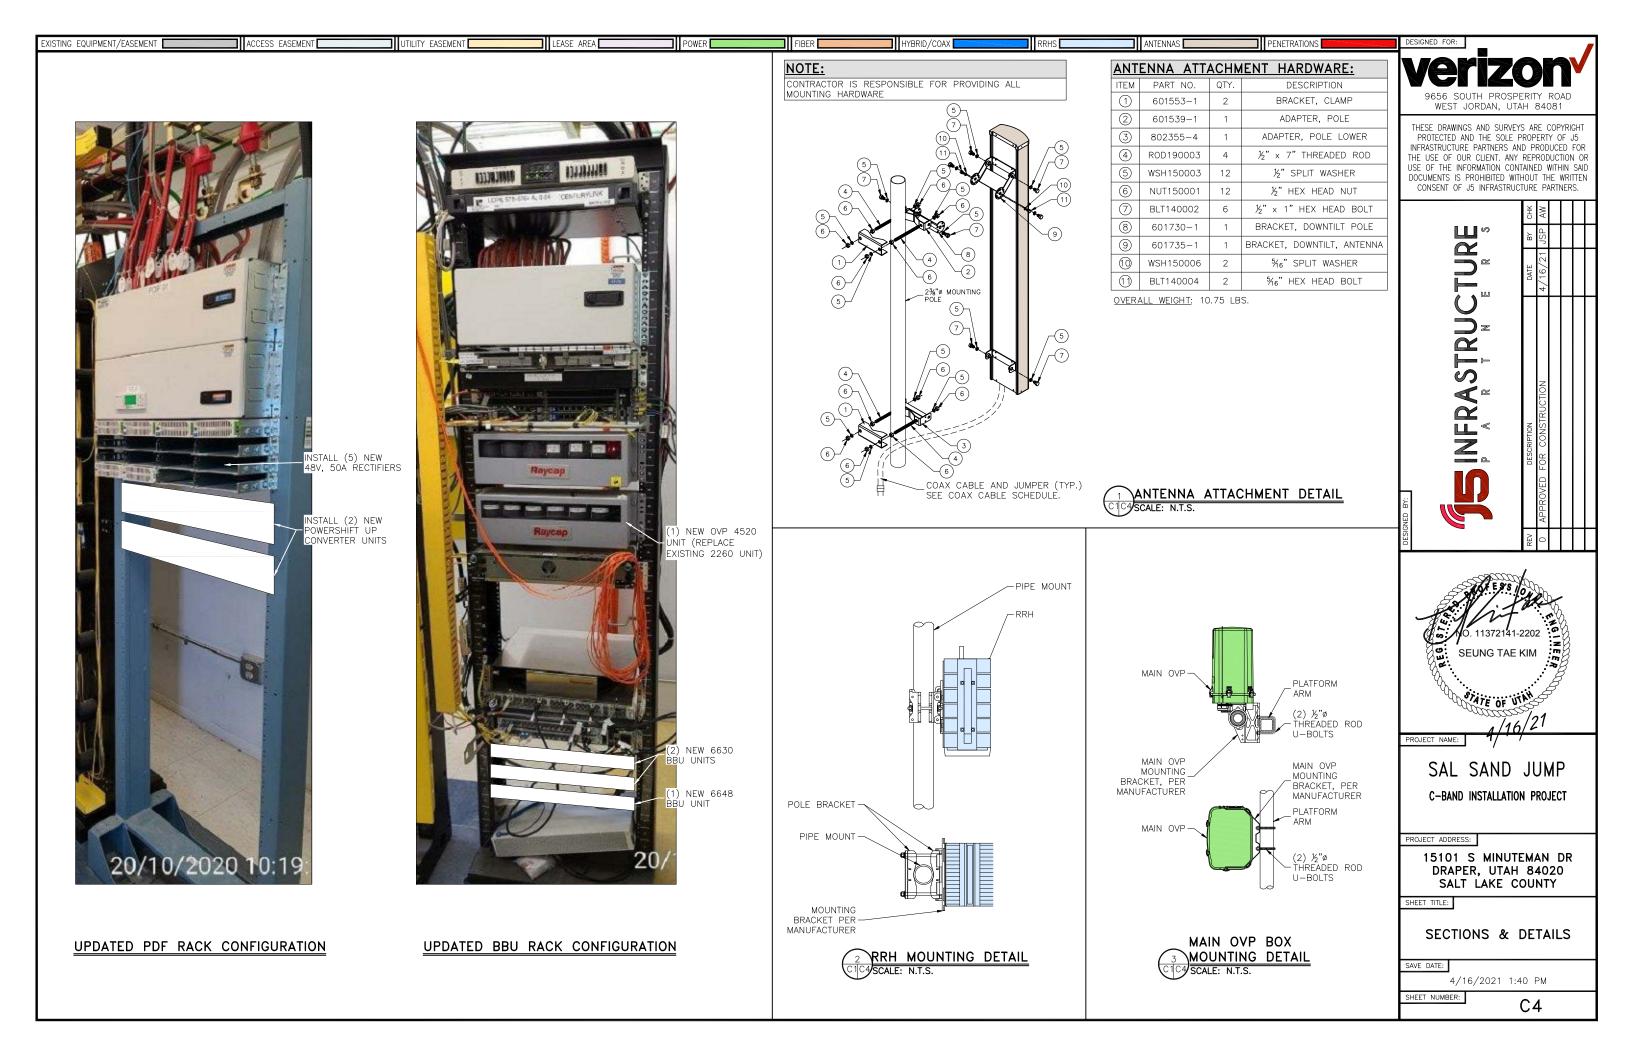

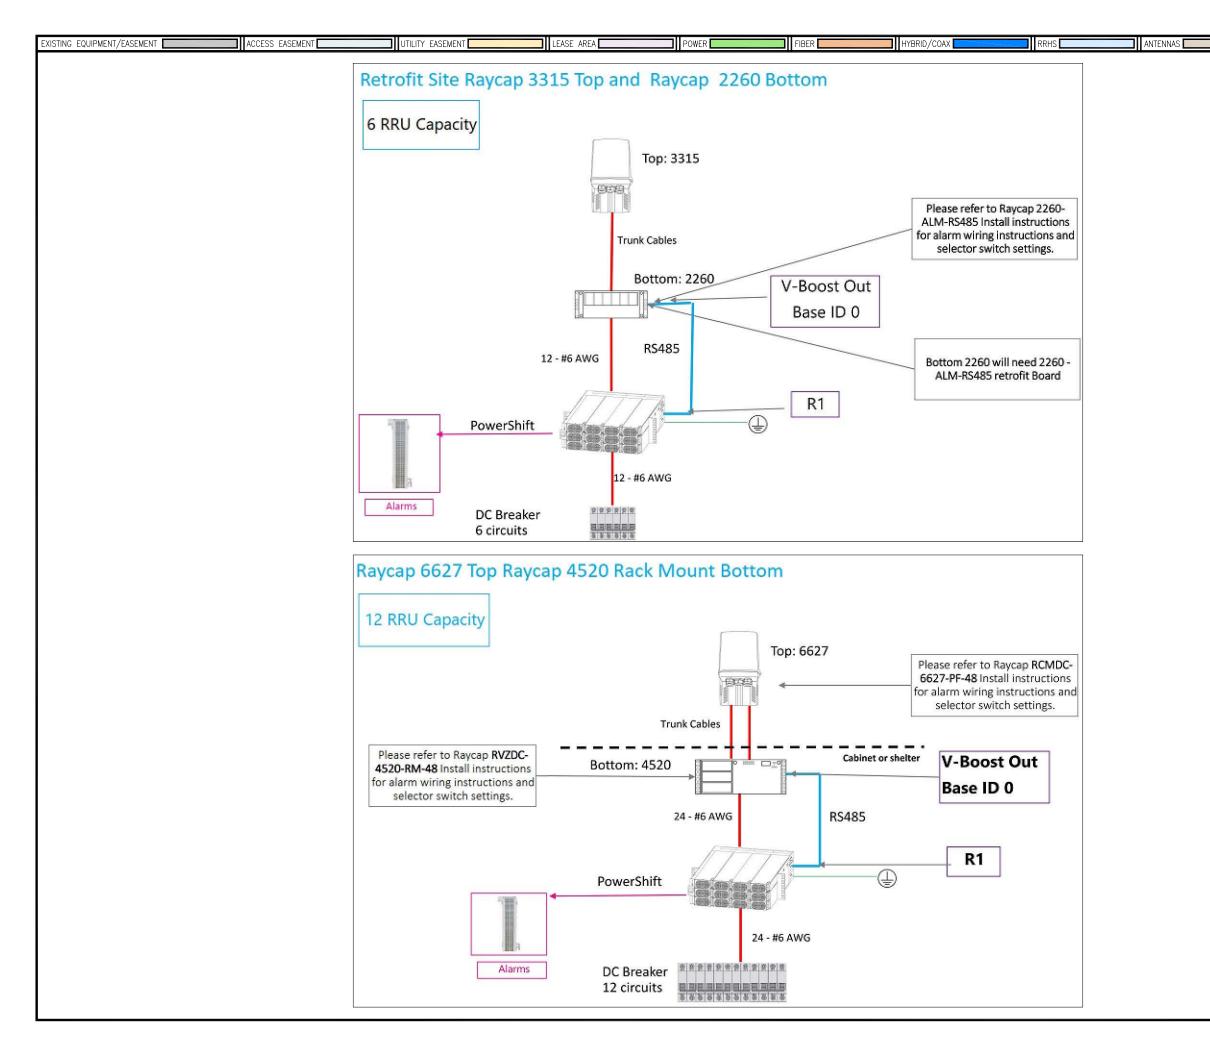

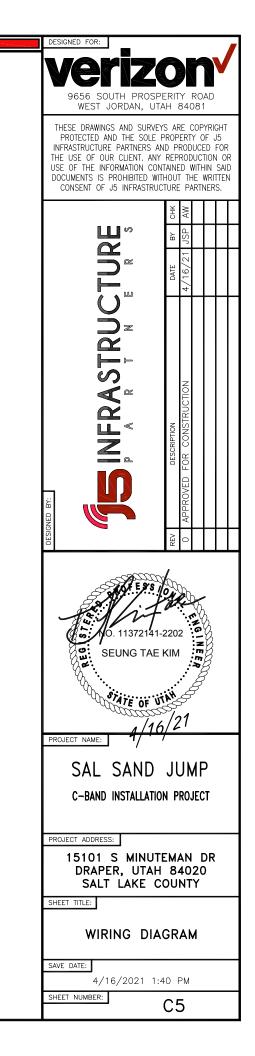

PENETRATIONS

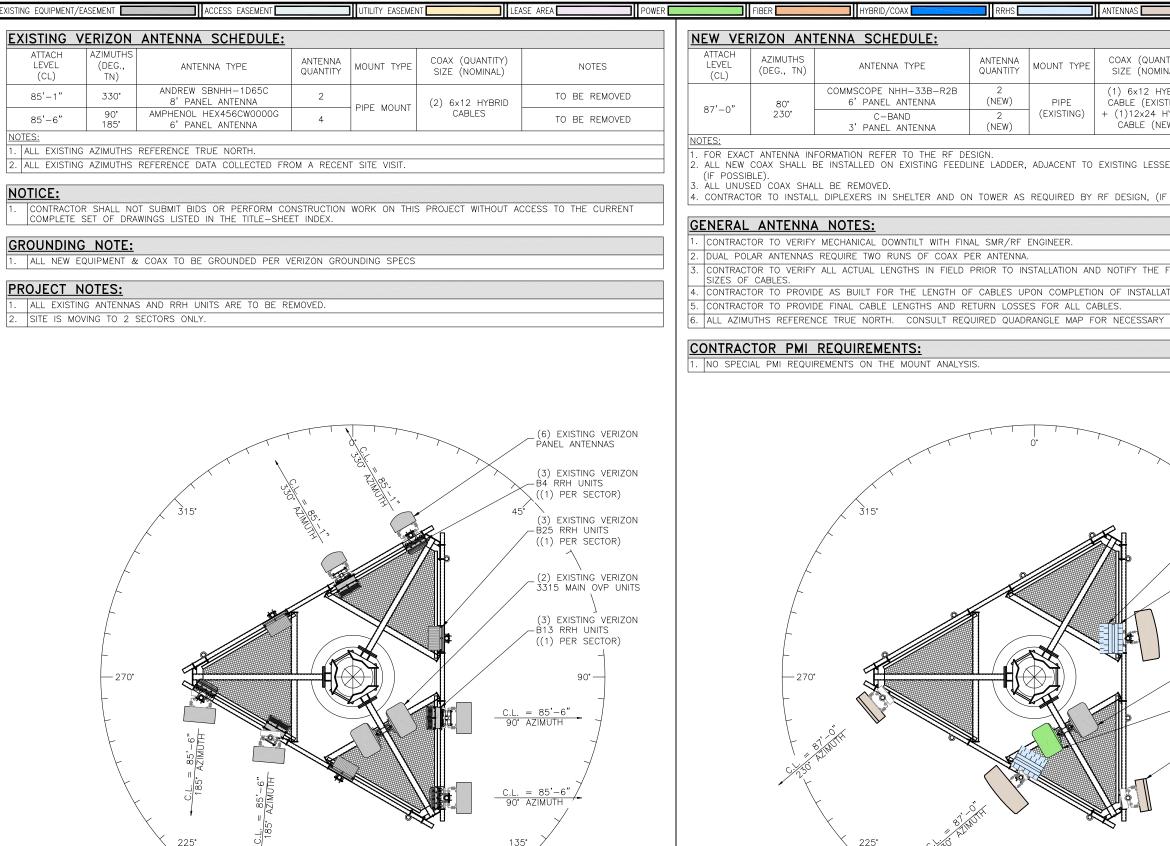

EXISTING ANTENNA SECTION AT 85'-1" & 85'-6"

SCALE: 1/4"=1'-0'

NORTH

	RRHS		ANTENNAS	PENETRATIONS		DESIGNED FOR:
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<u>_E:</u>	AN/TEN			00414 04215	LIFOLINI COL	aci ikai i
E	ANTENNA QUANTITY	MOUNT TYPE	COAX (QUANTITY) SIZE (NOMINAL)	COAX CABLE LENGTH	MECHANICAL DOWN TILT	9656 SOUTH PROSPERITY ROAD WEST JORDAN, UTAH 84081
3B-R2B NNA	2 (NEW)	PIPE	(1) 6x12 HYBRID CABLE (EXISTING)	SEE CHART ON	SEE RFDS	THESE DRAWINGS AND SURVEYS ARE COPYRIGHT PROTECTED AND THE SOLE PROPERTY OF J5
NNA	2 (NEW)	(EXISTING)	+ (1)12x24 HYBRID CABLE (NEW)	C3		INFRASTRUCTURE PARTNERS AND PRODUCED FOR THE USE OF OUR CLIENT. ANY REPRODUCTION OR USE OF THE INFORMATION CONTAINED WITHIN SAID
THE RF DE						DOCUMENTS IS PROHIBITED WITHOUT THE WRITTEN CONSENT OF J5 INFRASTRUCTURE PARTNERS.
FING FEEDL	INE LADDER,	, ADJACENT TO	EXISTING LESSEE COA	X. INSIDE OF MON	IOPOLE	AW
ER AND ON	N TOWER AS	REQUIRED BY	RF DESIGN, (IF APPLIC	CABLE)		
	IAL SMR/RF PER ANTENNA					
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* 7				PANEL ANTENI	NAS	C-BAND INSTALLATION PROJECT
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	i.		80	ALINE		PROJECT ADDRESS:
1 81	NUTT V	S.				15101 S MINUTEMAN DR
C.1230			13	55° Y		DRAPER, UTAH 84020 SALT LAKE COUNTY
-			<i></i>	/		SHEET TITLE:
Ζ,		190°				ANTENNA INFORMATION
		180°				SAVE DATE:
NEW A	ANTENNA /4"=1'-0"	SECTION	AT 87'-0"			4/16/2021 1:40 PM
/ SUALE: 1, H	/4 =1 -0					SHEET NUMBER: RF1
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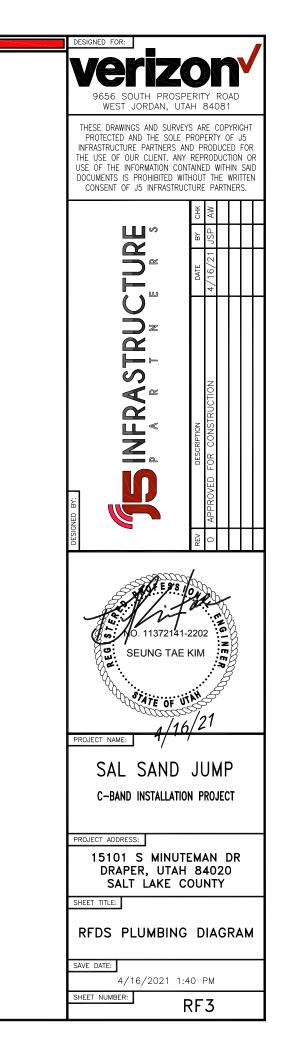
NORTH

existing equipment/easement Access easement Utility easement Lease area Power Fiber Hybrid/coax RHS Antennas									A
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Added 00 850) 190	0 AWS	AWS3	28 GHz	31 GHz	39 GHz	CBRS	LAA	L-Sub6	Make	Model	Centerline	Tip Height	Azimuth	RET	4xRx	inst. Type	Quantity	THESE DRAWINGS AND SURVEYS ARE C PROTECTED AND THE SOLE PROPERTY INFRASTRUCTURE PARTNERS AND PRODU THE USE OF OUR CLIENT. ANY REPRODU USE OF THE INFORMATION CONTAINED W
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re										AMPHENOL	HEX456CW0000X 7 10EDT (216649)	87	90	91(02) 190(03)	false	false	PHYSICAL	2	NED BY: DESCR APPROVED FOR C
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850) 190	0 AWS	AWS3	28 GHz	31 GHz	39 GHz	CBRS	LAA	L-Sub6	Make	Model	Centerline	Tip Height	Azimuth	RET	4xRx	inst. Type	Quantity	PROJECT NAME: 4/16/21
1											No data available.								SAL SAND JUN
									1	Added: 4	Removed: 7	R	etained: 0						JAL SAND JUN

THERE IS NO PLUMBING DIAGRAM IN THE CURRENT VERSION OF THE RFDS

EXISTING EQUIPMENT/EASEMENT	UTILITY EASEMENT	LEASE AREA	POWER	FIBER	HYBRID/COAX	RRHS	ANTENNAS



PENETRATIONS