

### **Development Review Committee**

1020 East Pioneer Road Draper, Utah 84020

### STAFF REPORT

April 7, 2021

To:	Jennifer Jastremsky	, Zoning Administrator	
	Approved	Date	

From: Maryann Pickering, AICP, Planner III

(801) 576-6391 or maryann.pickering@draperutah.gov

Re: Lone Peak Biotech Business Park 17 and 18 - Site Plan Review Request

Application No.: SPR-017-2021

Applicant: Russ Naylor representing Price Lone Peak Project Location: 12158 and 12094 S. Life Science Court

Current Zoning: CSD-LP (Lone Peak Commerical Special District)
Acreage: 11.34 acres (approximately 493,970 square feet)

Request: Request for approval of a site plan for two new manufacturing

buildings in the CSD-LP zone.

### **SUMMARY**

This application is a request for approval of a site plan for approximately 11.34 acres. The property is located one the west side of Life Science Court (see Exhibit B). The property is currently zoned CSD-LP. The applicant is requesting to allow for the development of a portion of the currently vacant sites with one building on each property.

### **BACKGROUND**

The site was subdivided in June, 2019. The plat that approved the sites for this development is called Lone Peak Biotech Business Park and created nine lots from 42.32 acres. This request is to develop lots 6 and 7 of the Lone Peak Biotech Business Park subdivision. The two lots together combine approximately 11.34 acres in size.

The developer entered into a Development Agreement with Draper City on March 19, 2019 allowing site plans within the Lone Peak Biotech Business Park to be approved by the Zoning Administrator rather than the Planning Commission.



### **ANALYSIS**

<u>General Plan and Zoning</u>. The Land Use Map of the General Plan calls for the Commercial Special District land use designation for the subject property (see Exhibit C). This category is characterized as follows:

### Commercial Special District

LAND USE DESCRIPTIO	N
CHARACTERISTICS	Include a wide range of commercial uses that are destination oriented and draw from a regional customer base
	<ul> <li>Compatible, master planned mix of day and evening uses consisting of office, light manufacturing, retail, residential, recreation and open space components</li> </ul>
	Limited traffic access points
	<ul> <li>Development is intended to consist of well designed, architecturally integrated structures which are appropriately landscaped and buffered from surrounding land uses</li> </ul>
	<ul> <li>Uniform design standards and aesthetics</li> </ul>
	<ul> <li>Access to individual properties should be provided only from frontage roads or major arterials</li> </ul>
	<ul> <li>Common off-street traffic circulation and parking areas</li> </ul>
LAND USE MIX	<ul> <li>Large-scale master-planned commercial centers</li> <li>Big box centers</li> </ul>
	Corporate headquarters
	Multi-story upscale office buildings
	Multi-story upscale residential buildings
COMPATIBLE ZONING	<ul> <li>Adopted Commercial Special District zone</li> <li>Adopted Major Freeway Arterial Frontage Road zone</li> </ul>
LOCATION	Strategically placed along high-traffic corridors with convenient points of traffic access to and from residential areas
	<ul> <li>Excellent transportation access to major highways</li> </ul>
	High visibility from the I-15 corridor
	Proximity to both Salt Lake and Utah Counties
	<ul> <li>Provide adequate buffers in the form of setbacks, open space, low impact industrial uses, barriers, etc. adjacent to existing residential areas</li> </ul>
	Major streets serving these areas should accommodate truck traffic

The property has been assigned the CSD-LP zoning classification. This zoning designation supports a variety of uses primarily geared toward manufacturing and office. The CSD-LP zone per Draper City Municipal Code (DCMC) Section 9-18G-010 is "is a master planned project with multiple architecturally compatible buildings fronting along 12300 South,

Draper City's major commercial corridor, and Lone Peak Parkway, Draper City's major commercial/industrial corridor."

The property is bounded by CSD-LP zoning to the north and east (see Exhibit D). There is CBP (Business Manufacturing Park) zoning to the south. To the west is a small area of A5 (Agricultural), which is part of the railroad right-of-way and both RM1 (Multiple Family Residential) and R3 (Single Family Residential) zoning designations.

<u>Site Plan Layout</u>. For the purposes of this staff report, the site will be defined as the 11.34 acres of the proposed two lots (lots 6 and 7) to be developed (see Exhibit E). The remainder of the subdivision that is currently vacant will be developed at a future date and will require separate site plan approval.

The site plan depicts a single building on each of the lots along with its associated parking and landscaping, etc. The applicant has indicated that a tenant has been obtained for the buildings and it is being built to their specifications.

Once the site is completely built out, the two buildings will be situated on the west side of Life Science Court. Each of the buildings is located centrally on the property with parking all around and a loading dock on one side. Landscaping is proposed along the street frontages as required by the CSD.


### Landscaping and Lot Coverage.

### Lot 7/Building 17

The building's footprint is designed to cover approximately 62,394 square feet of the 5.96 acre site. This provides lot coverage of just over 24% of the site. The maximum lot coverage allowed by the CSD is 50%. The site also contains 18,381 square feet of landscaping on the property, providing a site landscaping calculation of approximately 7.0%. The minimum amount of landscaping required per the CSD-LP is 10% for each phase within the business park. The overall landscaping for the Biotech portion of the business park is 213,474 square feet or approximately 13%. This site meets the minimum standard.

### Lot 6/Building 18

The building's footprint is designed to cover approximately 71,549 square feet of the 5.2 acre site. This provides lot coverage of just over 31.5% of the site. The maximum lot coverage allowed by the CSD is 50%. The site also contains 29,591 square feet of landscaping on the property, providing a site landscaping calculation of approximately 13.0%. The minimum amount of landscaping required per the CSD-LP is 10% for each phase within the business park. The overall landscaping for the Biotech portion of the business park is 213,474 square feet or approximately 13%. This site meets the minimum standard.

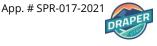

### Overall CSD Landscaping

A recent change to the text of the CSD removed the specific plant list that was at times difficult to comply with. The proposed plans for buildings 17 and 18 have landscaping species that are acceptable based on the updated CSD text.

<u>Parking</u>. According to DCMC Section 9-18G-060(C), there shall be a minimum of one parking space for every 1,000 square feet of industrial space. Each of the lots meets the minimum. A breakdown is as follows:

Lot 7/Building 17

Required: 63 parking spaces Provided: 84 parking spaces

Lot 6/Building 18

Required: 72 parking spaces Provided: 85 parking spaces

<u>Architecture</u>. Each of the three buildings are one story in height and there may be mezzanine space in a portion of each building. However, due to the proposed manufacturing use, the buildings are taller than a typical one story building. Both buildings 17 and 18 are approximately 40 feet tall. The CSD does not limit the number of stories within its boundaries, only the height. The maximum allowed is 60 feet so all buildings are well below the maximum allowed.

Within the CSD, there is a desired architectural theme and required design elements. Each of the two buildings do meet all of the minimum standards and the architectural style between the two is consistent. For the industrial portion of the CSD, the design elements are minimal. Exhibit C1 of the CSD provides a listing of preferred design elements and notes that each project shall incorporate a minimum of seven design elements.

The buildings are proposed to be color integrated concrete tilt up buildings with decorative reveals, offset in both the primary wall height and wall planes, recessed header reveal contrasting color, earth tone colors, and architectural grade exterior wall mounted light fixtures. Also included are decorative canopies at the main building entrance.

<u>Lighting</u>. The site plan calls for the installation of light poles on both sites. The applicant has provided a spec sheet for the proposed lighting fixture and it is proposed to be a full cutoff fixture, meaning all light will be directed downwards. All of the poles are proposed to be approximately 30 feet in height, which complies with the 30 foot maximum allowed within the CSD area. DCMC Section 9-18G-070(A) requires that all illumination drops to zero at all property lines. The photometric plan shows that all illumination standards have been met.

*Fencing.* There is no fencing that is required or proposed with this application.



<u>Criteria for Approval</u>. The criteria for review and potential approval of a site plan request is found in Sections 9-5-090(E) of the DCMC. This section depicts the standard of review for such requests as:

- E. Standards for Approval. The following standards shall apply to the approval of a site plan.
  - 1. The entire site shall be developed at one time unless a phased development plan is approved.
  - 2. A site plan shall conform to applicable standards set forth in this title, including but not limited to, building heights, setbacks, access points, parking, landscaping, and building materials.
  - 3. The proposed development plans meet the intent, goals, and objectives of the general plan and the purpose of the zone district in which the site is located.
  - 4. The public facilities and services in the area are adequate to support the subject development, as required by engineering standards and specifications.
  - 5. The proposed development plans comply with the engineering standards found in Titles 7, 8, 11, 12, 16, and 18 of this code, including traffic, storm water drainage, and utilities concerns.

### **REVIEWS**

<u>Planning Division Review</u>. The Draper City Planning Division has completed their review of the site plan submission. Comments from this division, if any, can be found in Exhibit A.

<u>Building Division Review</u>. The Draper City Building Division has completed their review of the site plan submission. Comments from this division, if any, can be found in Exhibit A.

<u>Engineering and Public Works Divisions Review</u>. The Draper City Engineering and Public Works Divisions have completed their review of the site plan submission. Comments from this division, if any, can be found in Exhibit A.

<u>Fire Division Review</u>. The Draper City Fire Marshal has completed his review of the site plan submission. Comments from this division, if any, can be found in Exhibit A.

<u>Geotechnical and Geologic Hazards Review</u>. Taylor Geo-Engineering, LLC in working with the Draper City Building and Engineering Divisions, has completed their review of the geotechnical and geologic hazards report submitted as a part of the site plan. Comments from Taylor Geo-Engineering, LLC, if any, can be found in Exhibit A.

<u>Legal Division Review</u>. The Draper City Attorney has completed his review of the site plan submission. The request complies with federal and state laws and Draper City ordinances. Comments from this division, if any, can be found in Exhibit A.

*Noticing*. Notice has been properly issued in the manner outlined in the City and State Codes.

#### STAFF RECOMMENDATION

Staff finds that the application complies with the DCMC and recommends that the Zoning Administrator review the request and approve the application based on the findings listed below and the criteria for approval, as listed within the staff report.

If the Zoning Administrator decides to approve the request, staff recommends they include the following conditions of approval:

- 1. That all requirements of the Draper City Engineering, Public Works, Building, Planning, and Fire Divisions are satisfied throughout the development of the site and the construction of all buildings on the site, including permitting.
- 2. That all requirements of the geotechnical report are satisfied throughout the development of the site and the construction of all buildings on the site.

The findings for approval as are follows:

- 1. The entire site shall be developed at one time unless a phased development plan is approved.
- 2. A site plan shall conform to applicable standards set forth in this title, including but not limited to, building heights, setbacks, access points, parking, landscaping, and building materials.
- 3. The proposed development plans meet the intent, goals, and objectives of the general plan and the purpose of the zone district in which the site is located.
- 4. The public facilities and services in the area are adequate to support the subject development, as required by engineering standards and specifications.
- 5. The proposed development plans comply with the engineering standards found in Titles 7, 8, 11, 12, 16, and 18 of this code, including traffic, storm water drainage, and utilities concerns.

#### DEVELOPMENT REVIEW COMMITTEE ACKNOWLEDGEMENT

We, the undersigned, as duly appointed members of the Draper City Development Review Committee, do acknowledge that the application which provides the subject for this staff report has been reviewed by the Committee and has been found to be appropriate for review by the Draper City Planning Commission and/or City Council.

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Draper City Public Works Division

Don Buckley

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Date: 2021.04.09 12.45.03-0600'

**Draper City Fire Department** 

Keith Collier Digitally signed by Keith Collier DN: C=US, E=keath. collier@draperutah.gov.

O=Draper City. OU=Building Official, CN=Keath collier Date: 2021.04.12 07:22:00-06'00'

Draper City Building Division

Jennifer Jastremsky

Discarding Designed by Jennifer Jastremsky

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Date: 2021 04.09 10.37.18-06:00

**Draper City Planning Division** 

Mike Barker Digitally signed by Mike Barker Date: 2021.04.09 10:53:35 -06'00'

Draper City Legal Counsel

## EXHIBIT A DEPARTMENT REVIEWS

REVIEWS ARE NOT MEANT TO BE AN ALL INCLUSIVE LIST OF POSSIBLE COMMENTS OR CONDITIONS.

### Planning Division Review.

No additional comments provided.

### **Building Division Review.**

No additional comments provided.

### Engineering and Public Works Divisions Review.

No additional comments provided.

### Fire Division Review.

No additional comments provided.

### Geotechnical and Geologic Hazards Review.

See attached

### Legal Review.

1. The request complies with federal and state laws and Draper City ordinances.



2650 North 180 East Lehi, Utah 84043 P. 801-766-3246 F. 801-769-3336

March 19, 2021

Mr. Keith Collier Chief Building Official Draper City 1020 East Pioneer Road Draper, Utah 84020

Subject: Geotechnical Review

Lone Peak BioTech Business Park, Lots 6 and 7

12094 and 12158 South Life Science Court

Draper, Utah

TG Project No. 21040

Draper City Application No. SPR-000017-2021

Subject Document: Gordon Geotechnical Engineering, Inc., Supplemental Discussions and

Recommendations (Revision 1) Report, Geotechnical Study, Proposed Lone Peak BioTech Business Park - Buildings 17 & 18, Between Lone Peak Parkway on the East and the Mainline Rail Road Trax on the West at Approximately 1200 South, Draper, Utah, G2 Project No. 024-008-19, prepared for Lone Peak BioTech Business Park, LLC, c/o Price Realty Group, 230 East South Temple, Salt Lake City, Utah 84111, dated March

2, 2021.

Review Status: GEOTECHNICAL SUBMITTAL COMPLETE

Dear Mr. Collier:

At your request, Taylor Geotechnical (TG) reviewed the above subject document prepared by Gordon Geotechnical Engineering, Inc. (G2). The purpose of TG's review is to evaluate whether or not G2 adequately addresses geotechnical engineering parameters at the property, as applicable to commercial development, consistent with concerns for public health, safety, reasonable professional standard of practice and Draper City's Geologic Hazards Ordinance, Appendix D, Minimum Standards for Liquefaction Investigations (Draper City, 2010).

G2 previously completed a geotechnical study for the Lone Peak BioTech Business Park on April 21, 2017 (G2 2017a). Supplemental reports were completed for the Lone Peak BioTech Business Park on May 26, 2017 (G2 2017b) and on June 8, 2017 (G2 2017c).

Due to poorly documented site grading fill placed on Lot 6 (Building 18) and Lot 7 (Building 17) of the Lone Peak BioTech Business Park development, G2 prepared the subject document. The

March 2, 2021, G2 document provided updated geotechnical recommendations for support of footings on the poorly documented fill.

### **TG Conclusion**

Based substantially in and on reliance of the technical documentation and assurances provided by G2, including their opinions and conclusions, it is TG's opinion that the G2 submittal has adequately addressed geotechnical parameters at the site, consistent with concerns for public health, safety and welfare and reasonable professional standards of practice.

A site specific liquefaction study was completed for the subject site with the results presented in the April 21, 2012, G2 document (G2 2017a). G2 calculated that the site is susceptible to 0.5 inches of liquefaction induced settlement and the site is not susceptible to liquefaction induced lateral spread.

### **Public Right-of-Way**

Public right-of-way improvements are complete for the subdivision.

### **Geotechnical Report Summary for Plan Review**

- 1. Construction will consist of a tilt-up concrete and steel construction with slab on grade floors. Structural loads for the structures are anticipated to consist of column loads up to 170 kips and wall loads up to 8 kips per linear foot.
- 2. All organics, topsoil, existing fill and other deleterious material should be removed from below proposed building and pavement areas.
- 3. Footings may be supported on native undisturbed soils or on a maximum of 3 feet of compacted structural fill extending to native soils. Footings for the structures may be designed using an allowable bearing capacity of 2,500 psf.
- 4. A minimum of 12 inches of compacted granular fill is required below spread footings supporting column between 100 kips and 150 kips. A minimum of 12 inches of compacted granular fill is required below strip footings supporting walls loads between 5 kips per linear foot and 8 kips per linear foot.
- 5. Footings susceptible to frost should be located a minimum depth of 30 inches. Footings not susceptible to frost should have a minimum embedment of 15 inches.
- 6. Basement construction is not anticipated.
- 7. Seismic analysis of proposed structures at the site should be based on the following factored spectral response acceleration of 1.393g for S<sub>MS</sub>. Additional analysis is required for long period response accelerations depending on the impact seismic loading has on

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the structure and if needed by the structural engineer. The design spectral accelerations should be based on using Site Class = D. The spectral response accelerations should be multiplied by 2/3 to obtain the spectral response design acceleration values.

- 8. Type I or IA cement may be used for concrete placed in contact with natural soil.
- 9. All import materials should be approved by the Geotechnical Engineer.
- 10. All compaction for interior and exterior backfill adjacent to the building should be verified by the geotechnical engineer.
- 11. Prior to the placement of concrete, a letter from the geotechnical engineer should be obtained that indicates subgrade for footing and floor slab support was prepared in accordance with the April 21, 2017, G2 geotechnical report and the March 2, 2021, G2 supplemental report and ready for the placement of concrete.

#### **CLOSURE**

This letter is issued solely in response to the Consultants' evaluation of the referenced site. Comments and recommendations in this review are based on data presented in the referenced reports. Taylor Geotechnical accordingly provides no warranty that the data in the referenced reports is correct or accurate, and has not performed an independent site evaluation. Comments and recommendations presented herein are provided to aid Draper City in reducing risks from geotechnical hazards and to protect public health and safety.

All services performed by Taylor Geotechnical for this review were provided for the exclusive use and benefit of Draper City. No other person or entity is entitled to use or rely upon any of the information or reports generated by Taylor Geotechnical as a result of this review.

If you have any questions, please feel free to contact the undersigned. The opportunity to be of continued service to Draper City is appreciated.

Respectfully submitted, Taylor Geotechnical

Alanson O. Taylor, P.E. Principal

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### **References Cited**

Draper City, 2010, Chapter 9-19 Geologic hazard ordinance of Title 9 Land Use and Development Code for Draper City, adopted December 30, 2003, per Ordinance No. 547; amended December 11, 2007 per Ordinance No. 796; amended June 1, 2010, per Ordinance No. 935.

http://ut-drapercity.civicplus.com/documentcenter/view/379

Gordon Geotechnical Engineering, Inc., G2 2017a, Report, Geotechnical Study, Proposed Lone Peak Biotech Business Park, Between Lone Peak Parkway on the East and the Mainline Rail Road Trax on the West at Approximately 1200 South, Draper, Utah, G2 Project No. 0.24-008-17, prepared for Lone Peak BioTech Business Park, LLC, c/o Price Realty Group, 230 East South Temple, Salt Lake City, Utah 84111, dated April 21, 2017.

Gordon Geotechnical Engineering, In., G2 2017b, Response Letter to Taylor Geotechnical, Report, Geotechnical Study, Proposed Lone Peak Biotech Business Park, Between Lone Peak Parkway on the East and the Mainline Rail Road Trax on the West at Approximately 12200 South, Draper, Utah," G2 Project No. 0.24-008-17, prepared for Lone Peak BioTech Business Park, LLC, c/o Price Realty Group, 230 East South Temple, Salt Lake City, Utah 84111, dated May 26, 2017.


Gordon Geotechnical Engineering, In., G2 2017c, Response Letter to Taylor Geotechnical, Review Letter Dated June 1, 2017, Draper City Application No. SUB-125-2017, Lone Peak Biotech Business Park LLC, G2 Project No. 0.24-008-17, prepared for Lone Peak BioTech Business Park, LLC, c/o Price Realty Group, 230 East South Temple, Salt Lake City, Utah 84111, dated June 8, 2017.

Taylor Geotechnical Page 4 of 4


# EXHIBIT B AERIAL MAP




# EXHIBIT C LAND USE MAP

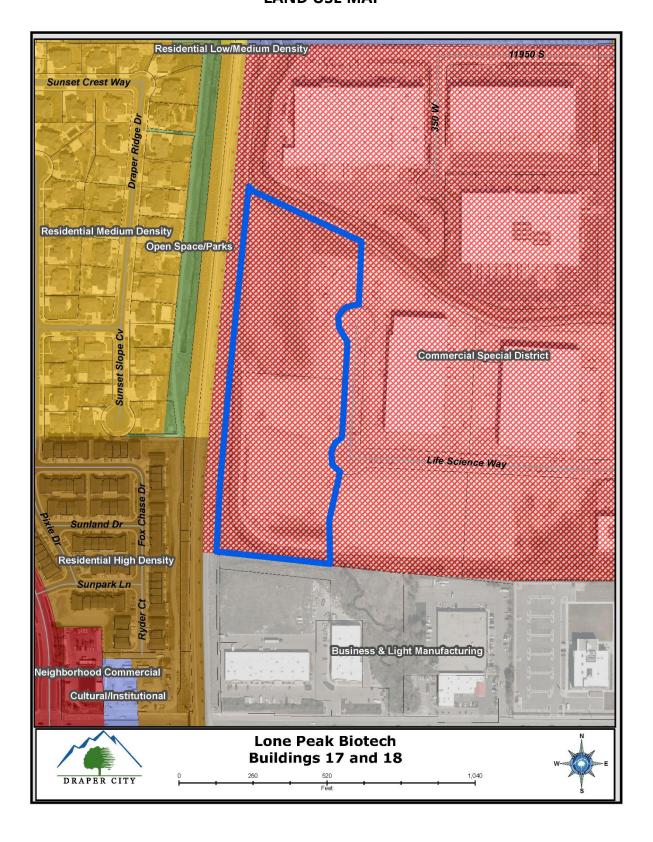


# EXHIBIT D ZONING MAP

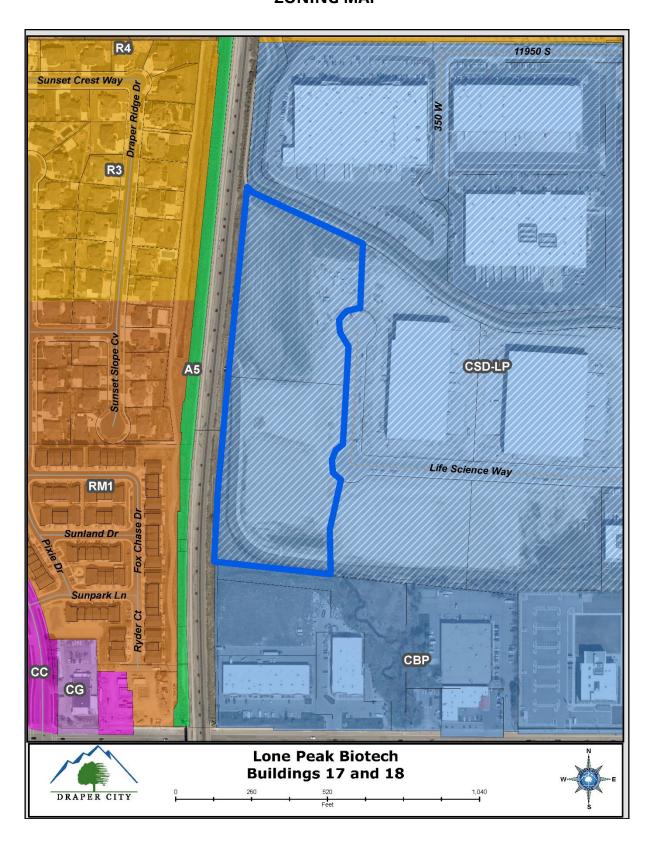


# EXHIBIT E SITE PLAN

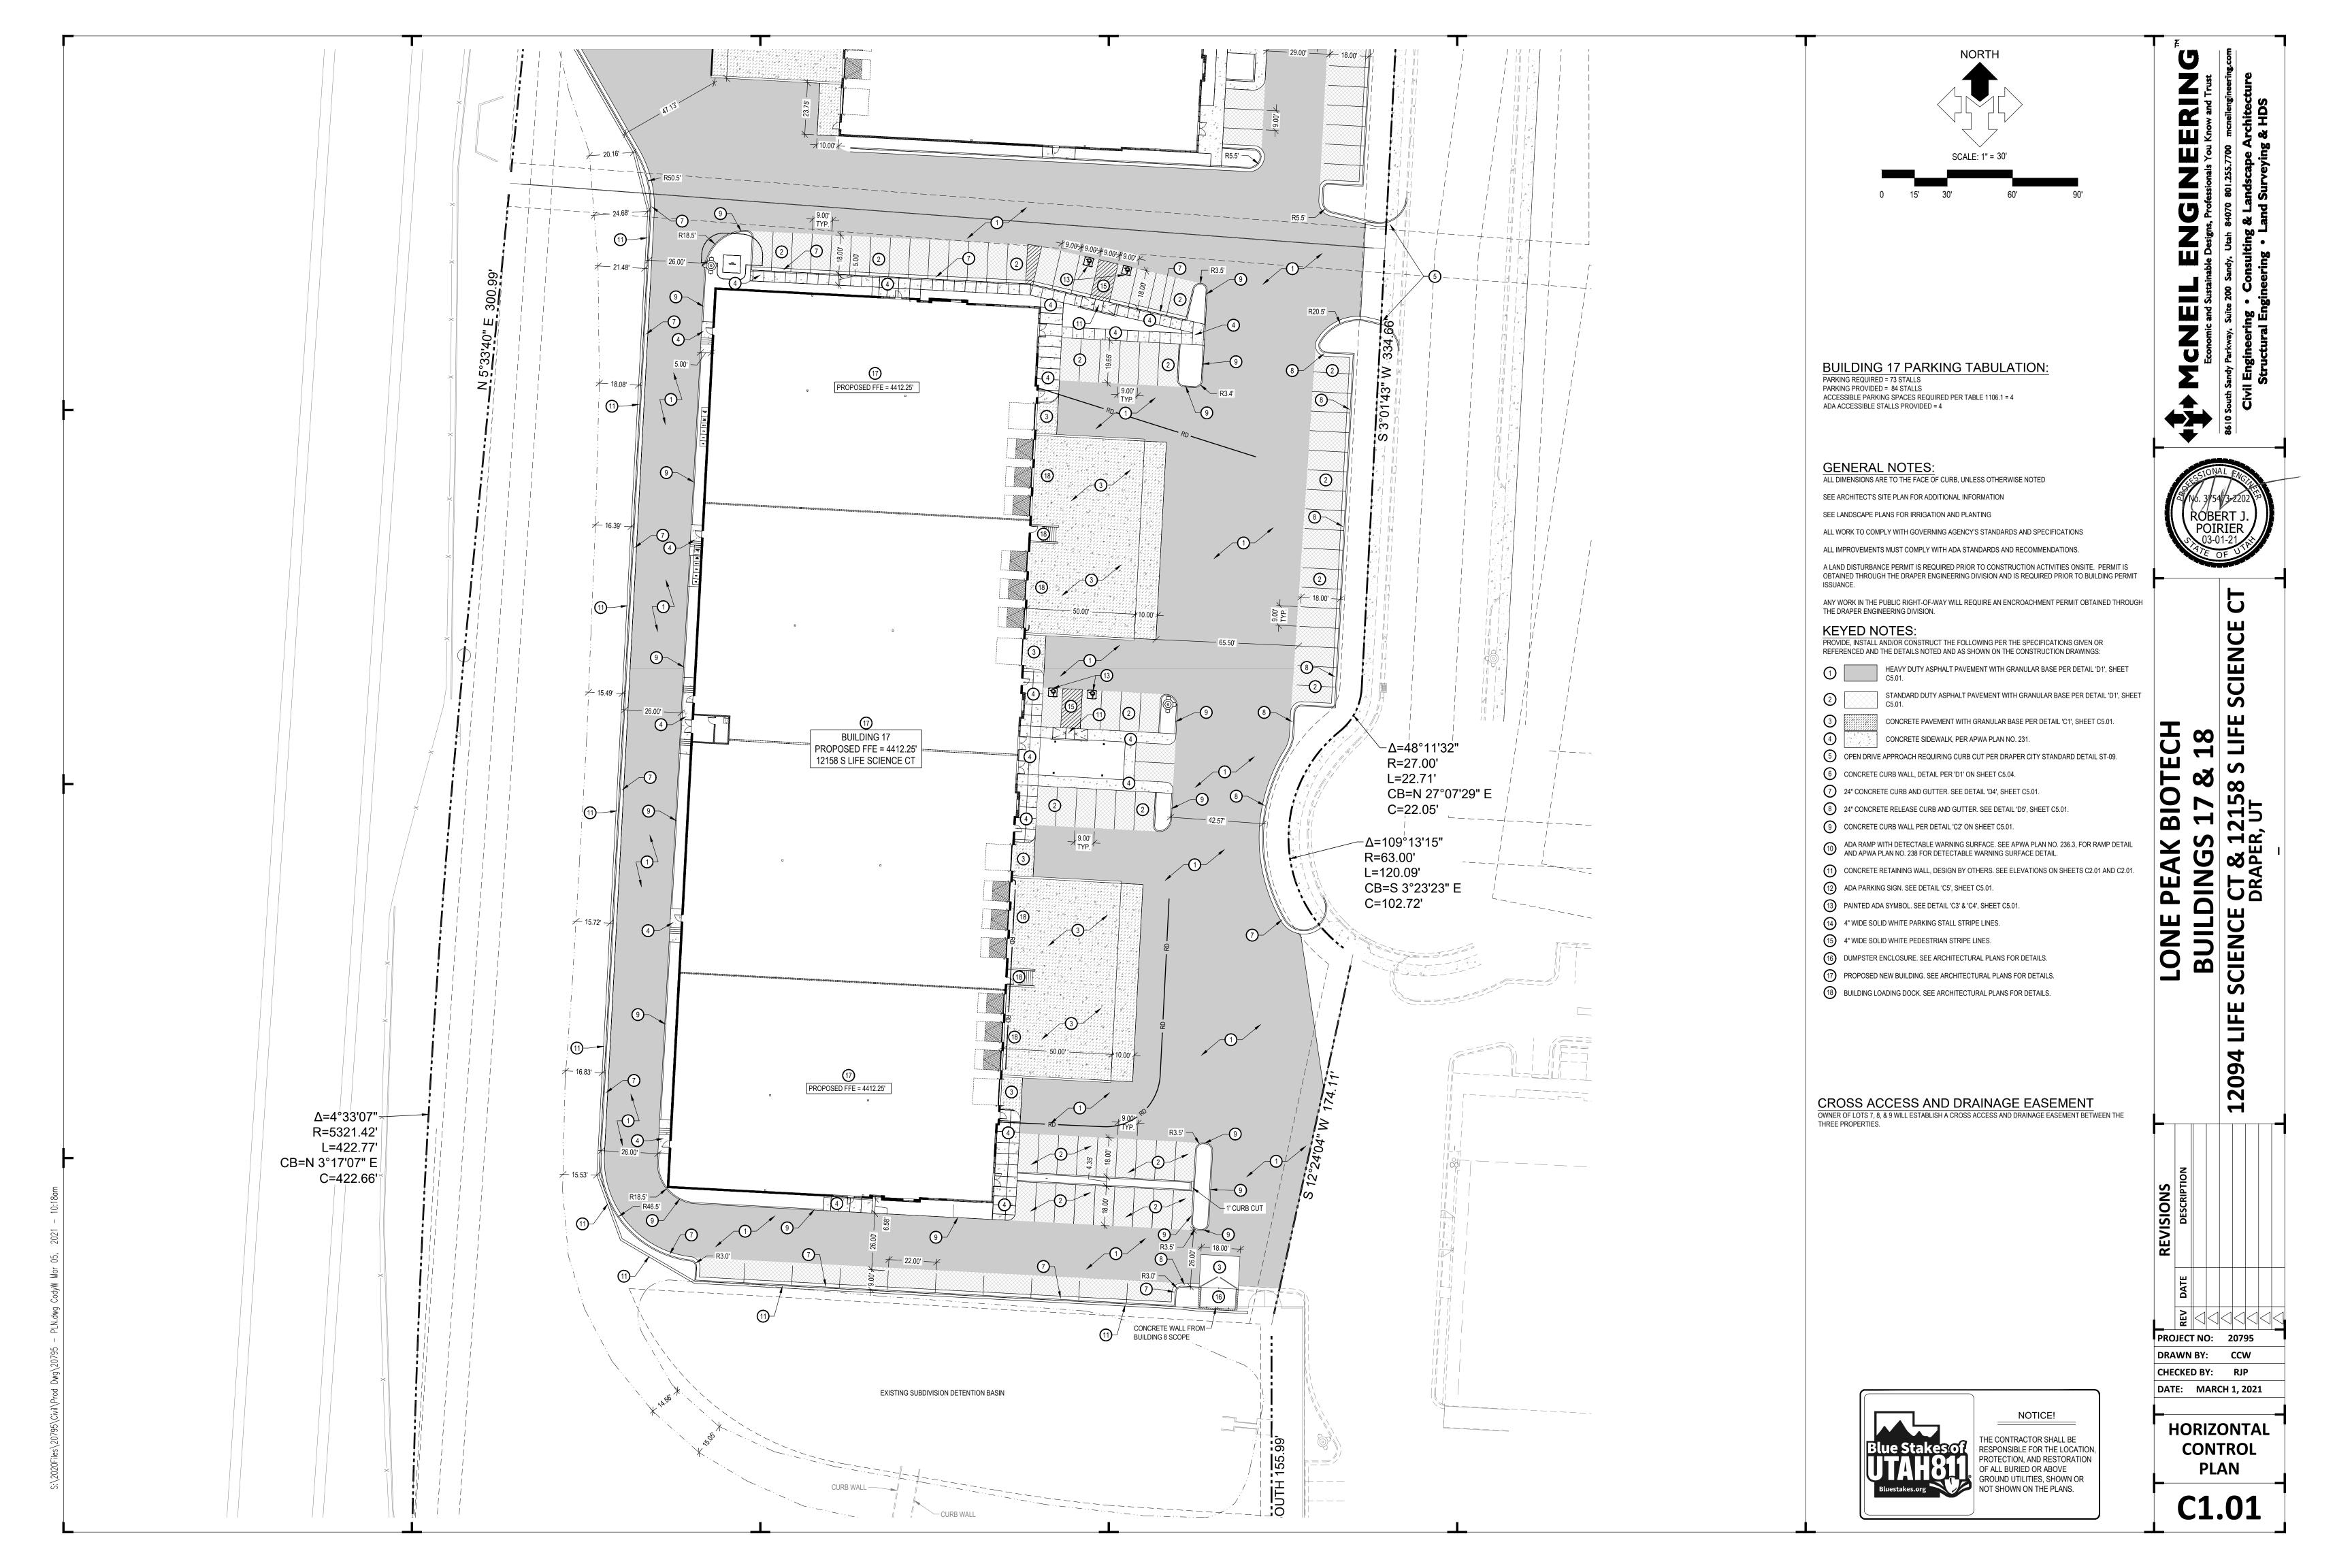

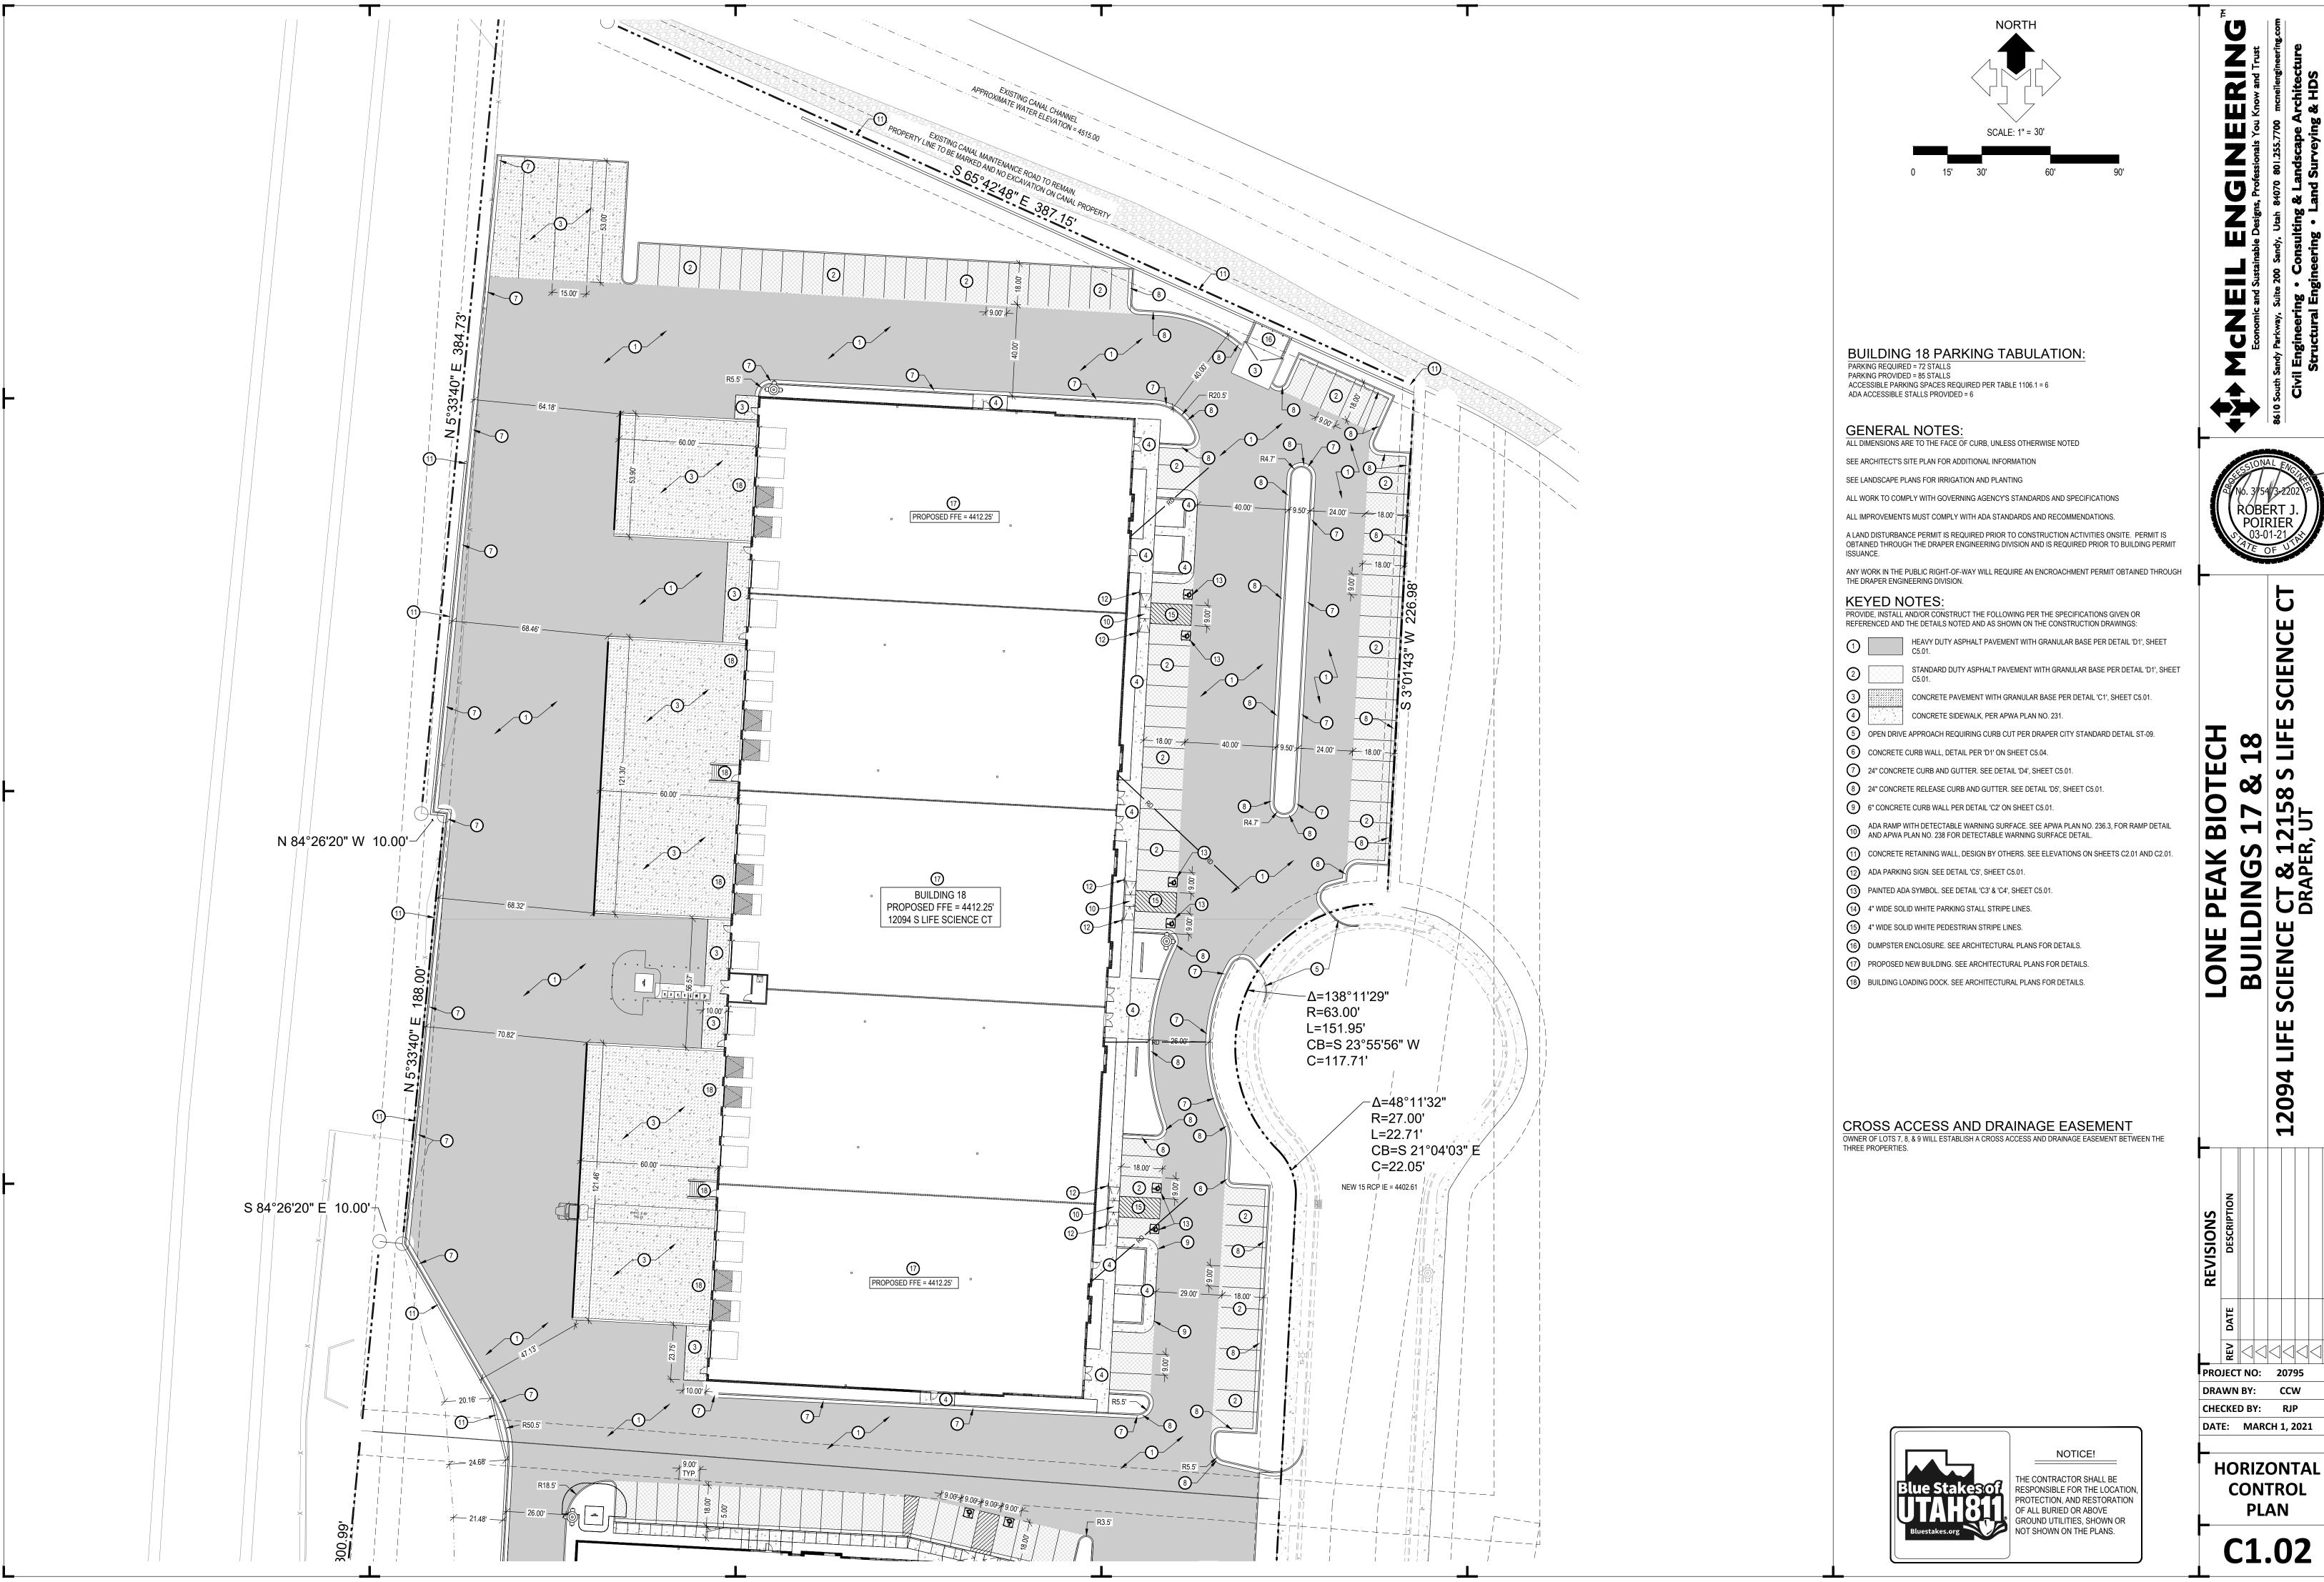



### EXHIBIT F LANDSCAPE PLAN

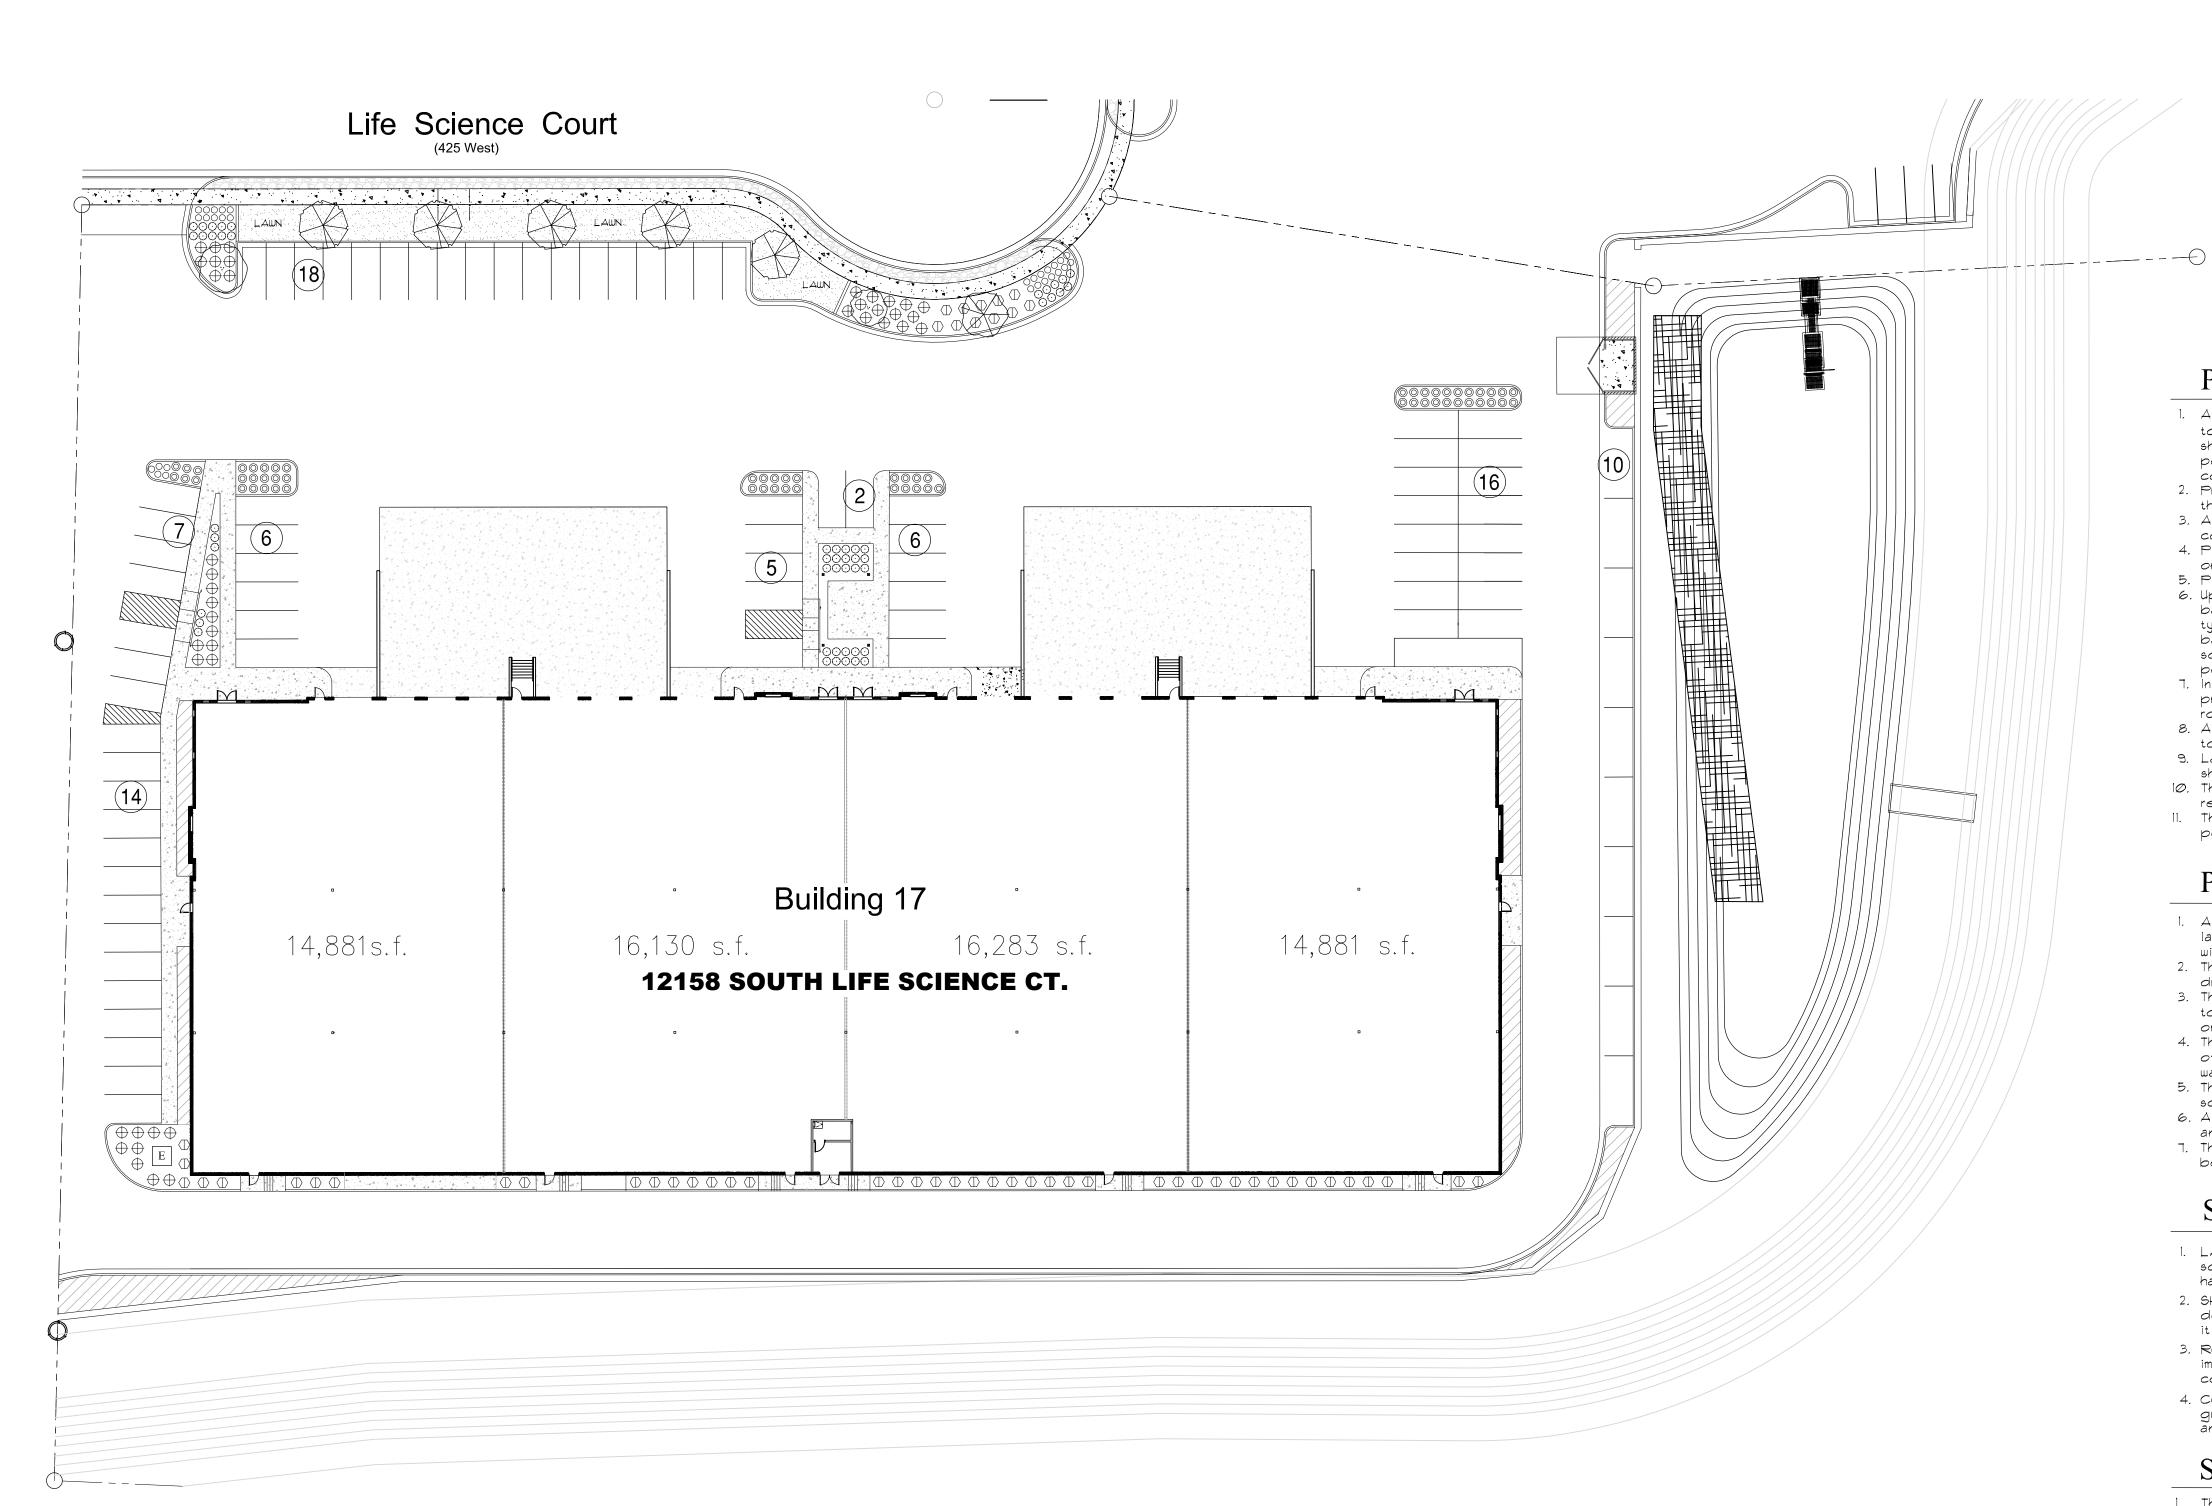

## TOPSOIL QUALITY GUIDELINES (All Soil Tests & Chemical Anaylsis Reports Shall Contain The Following Minimum Information)

Topsoil Sample Specification	pН	Soluble Salts dS/m or mmho/cm	Sodium Absorption Ratio (SAR)	Organic Matter %	Sand %	Silt %	Clay %	Texture Class
Ideal	5.5-7.5	-2	-3	= +2.0	-TØ	-70	-3Ø	Loam (L), Silt Loam (SiL)
Acceptable	5.0-8.2	-4	3-1 For (Sil, SiCL, CL) 3-1Ø For (SCL, SL, L)	= +1.0	-TØ	-70	-3Ø	Sandy Clay Loam (SCL), Sandy Loam (SL), Clay Loam (CL), Silt Clay Loam (SiCL.
Suspect	-5.0/+8.2	+4	+10	-1.0	= +70	= + <b>⊺</b> ∅	= +3Ø	Loamy Sand (LS), Sandy Clay (SC), Silty Clay (SiC), Sand (S), Silt (Si), Clay (C)
Nutrient Specification		Nitrogen (ppm)	Phosphorus (ppm)	Potassium	(ppm)	Iron (pp	m)	
Specification	1	+2Ø	+15	+150		+10		( "-" represents less than, "+" represents greater than, "=" represents equal to)

Legend	Legend						
Symbol	Description	Remarks					
	Concrete Mowstrip / Poured In Place / 10"W x 8"D Dimension See Detail 3, Drawing L1.2	Install In True, Straight Lines & Flush To All Curbs, Walks & Other Surfaces. Provide 4" Depth Base Material And Compact Subgrade And Material To Minimum 95%.					
LAUN	New Lawn Areas / Sod Material To Be Composed Of Drought Tolerant Varieites.	Install In Areas Shown, And Over A 6" Depth Of Import Topsoil. Sod Material To Be Composed Of Multiple Drought Tolerant Bluegrass Varieties. Provide Cutsheet Of Exact Product.					
No Hatch	Decorative Rock/ 1"-1 1/2" Size / "Wasatch Grey" Product / Delivered To Site "Un-Washed"	Insall To A Uniform Depth Of 4", And Over Weed Barrier Fabric. Provide (2) Applications Of Pre-Emergent Herbicide As Noted. All Rock Product Shall Be Washed On-Site Prior To Installation.					
	Decorative Rock/ 1"-1 1/2" Size / "Wasatch Grey" Product / Delivered To Site "Un-Washed"	These Areas To Receive Rock "ONLY", & "NO" Topsoil Beneath. Provide (2) Applications Of Pre-Emergent Herbicide As Noted. All Rock Product Shall Be Washed On-Site Prior To Installation.					
	Decorative Rock/2"-4" Size /	Work in Parkstrips Completed Under Separate Contract By Owner, And Prior To Installation					

New Condition.

"Olympus" Product / Installed Under Separate Contract.

Of All Other Work On The Project. Any Damages To Existing Work Shall Be Repaired To

# Plant List (TREES) / Building 17

Quan.	Symbol	Botanical Name	Common Name	Size	Remarks
	· )				
2		Liquidambar sty. 'Slender Silhouette'	Slender Silhouette Sweet Gum	1 1/2" Cal. 8'-10' Ht.	Full Heads Matching
1		Syringa reticulata 'Ivory Silk'	Japanese Tree Lilac	2" Cal. 8'-10' Ht.	Full Heads Matching
5		Zelcova serrata 'Musashino'	Musashino Columnar Zelcova	2 1/2" Cal. 10'-12' Ht.	Full Heads Matching

## Plant List (ORNAMENTAL GRASSES) / Building 17

Quan.	Symbol	Botanical Name	Common Name	Size	Remarks
41	$\oplus$	Calamagrostis acut. 'Avalanche'	Avalanche Feather Grass	5 Gallon	18" - 24" Ht.
55		Calamagrostis acut. 'Karl Foerster'	Karl Foerster Feather Grass	5 Gallon	18" - 24" Ht.
Ø	$\oplus$	Calamagrostis acut. 'Overdam'	Overdam Feather Grass	5 Gallon	18" - 24" Ht.
62	0	Pennisetum alop. 'Hameln'	Hameln Dw. Fountain Grass	5 Gallon	15" - 18" Ht.
50	0	Pennisetum alop. 'Little Bunny'	Little Bunny Dw. Fountain Grass	5 Gallon	12" - 15" Ht.
29	0	Sesleria autumnalis	Autumn Moor Grass	2 Gallon	12" - 15" Ht.


\*\* Plant quantities are provided for convenience ONLY!! The contractor shall provide and install all plants either shown or noted on the plans.



### Landscape Architect

RDL Design Company, Inc. 1020 East Yale Avenue Salt Lake City, Utah 84105

Phone: 801-647-3114 Email: rolldesign@comcast.net

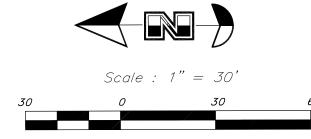

## Planting Notes

- 1. All shrub planting areas shall receive a 12 inch depth of topsoil, all lawn areas (if designed) a 6 inch depth of topsoil. Topsoil is not available at the site and must be imported from an approved local source. All topsoil shall be of a sandy loam consistency. The contractor shall supply a sample and chemical analysis of the proposed topsoil from a reputable topsoil company. The chemical analysis shall be of an acceptable range as
- compared to the "Topso'il Quality Guidelines" table shown on this drawing.

  2. Prior to placement of topsoil, all subgrade areas shall be loosened by scarifying the soil to a 6 inch depth, by the use of mechanical means, in order to create a transition layer between soils.
- 3. All plant material holes shall be dug a minimum twice the diameter of the rootball and level with bottom of plant container. Sub-grade material shall be removed from the site, or used in site backfill prior to topsoil placement. 4. Plant backfill mixture shall be composed of 3 parts topsoil to 1 part humus additive, and shall be rotary mixed
- on-site prior to installation. A pre-mixed soil medium can be used as an alternative. 5. Plant fertilizer shall be 'Agriform' brand 21 gram tablets used as per recommendations.
- 6. Upon completion of planting operations, all shrub pits and tree wells shall receive a 4 inch depth of fine ground bark mulch cover. The actual bed areas shall receive a minimum 4 inch depth of decorative stone, the specified type is "Wasatch Grey", 1"-1 1/2" & available from a local source. All areas shall receive "DeWitt" Pro-5 weed barrier fabric prior to installation. Pre-emergent herbicide to be applied to all areas, one application of topsoil prior to fabric installation, the other on top of decorative stone following the installation. All rock to be
- 7. In decorative rock beds, cut the fabric from around the water ring of each plant, then apply the 4" depth of bark product inside water ring to extents specified. The remainder of the planter bed shall receive the decorative rock to depth specified, over the weed barrier fabric and 2 pre-emergent herbicide applications.
- 8. All lawn areas shall be installed using a water conservative mixture, and shall be composed of multiple drought tolerant Bluegrass varieties. Provide cutsheet of exact product.
- 9. Landscape maintenance shall be required for a period through the second mowing of the lawn (30 days min.) and shall include mowing, weeding, pruning and one fertilization. 10. The project shall be swept clean of dirt and debris prior to completion of the project, and on a daily basis, if
- required, as determined by the Owner/contractor. II. The contractor shall comply with all warranties and guarantees set forth by the Owner, and in no case shall that

power washed on-site by contractor, using whatever means necessary, prior to rock installation.

period be less than one year following the date of completion and acceptance.

## Planting General Notes

- 1. All bidding landscape contractors shall have a minimum of 5 years experience in the installation of commercial landscape and irrigation projects, and be able to supply the necesarry staff to perform all tasks associated with these drawings, and in a professional and timely manner.
- 2. The landscape contractor, at all times, shall have personnel on-site experienced in being able to interpret the drawings correctly, and accurately measure the design layout using the specified scale.
- 3. The contractor shall verify the exact location of all existing and proposed utilities, and all site conditions prior to beginning work. The contractor shall coordinate their work with the project manager and all other contract-
- 4. The finish grade of all planting areas shall be smooth, even and consistent, free of any humps, depressions or other grading irregularities. The finish grade of all landscape areas shall be graded consistently 1/2" below all
- 5. The contractor shall provide all materials, labor and equipment required for the proper completion of all landscape work as specified and shown on the drawings.
- 6. All plant materials shall be approved prior to planting. The Owner/Landscape Architect has the right to reject any and all plant material not conforming to the specifications.
- 7. The contractor shall plant all plants per the planting details, stake/guy as shown. The top of the rootballs shall be planted flush with the finish grade.

## Sub-Grade Requirements

- 1. LAWN AREAS: Nine (9) inches below finish grade. This will allow for the installation of a six inch depth of topsoil along with the sodding material, leaving the top of sodding 1" below finish grade of adjacent concrete and
- 2. SHRUB AREAS: Nineteen (19) inches below finish grade. This will allow for the installation of a twelve inch depth of topsoil along with a six inch minimum depth of decorative rock mulch and weed barrier fabric, leaving it I inch below finish grade of adjacent concrete and hardscape areas.
- 3. ROCK "ONLY" AREAS: Five (5) inches below finish grade. This will allow for the installation of a four inch minimum depth of decorative rock mulch and weed barrier fabric, leaving it 1 inch below finish grade of adjacent concrete and hardscape areas.
- 4. COORDINATION: The Landscape Contractor shall meet early on in the construction process with the earthwork/ grading contractor to discuss and ensure that all sub-grade elevations, per these requirements, are established

## Submittal Requirements

- 1. The contractor shall provide to the Owner/Engineer product samples of all landscape materials such as boulders, decorative stone, bark mulches, weed barrier fabric, soil ammendments & import topsoil in order to obtain approval to be used on the project, and prior to any shipment to the site. Failure to provide this in a timely manner will in no way affect the construction schedule and time for project completion.
- 2. All plant materials shall be secured for the project a minimum of 60 days prior to shipment to the site. The contractor shall provide to the Owner/Engineer written confirmation of this a minimum of 30 days prior to planting of

## Plant List (TREES) / Building 18

Quan.	Symbol	Botanical Name	Common Name	Size	Remarks
5		Liquidambar sty. 'Slender Silhouette'	Slender Silhouette Sweet Gum	1 1/2" Cal. 8'-10' Ht.	Full Heads Matching
3		Malus sp. 'Spring Snow'	Spring Snow Crab	2 1/2" Cal. 8'-10' Ht.	Full Heads Matching
2		Syringa reticulata 'Ivory Silk'	Japanese Tree Lilac	2" Cal. 8'-10' Ht.	Full Heads Matching
3		Zelcova serrata 'Musashino'	Musashino Columnar Zelcova	2 1/2" Cal. 10'-12' Ht.	Full Heads Matching

## Plant List (ORNAMENTAL GRASSES) / Building 18


Quan.	Symbol	Botanical Name	Common Name	Size	Remarks
48	$\oplus$	Calamagrostis acut. 'Avalanche'	Avalanche Feather Grass	5 Gallon	18" - 24" Ht.
22	$\bigcirc$	Calamagrostis acut. 'Karl Foerster'	Karl Foerster Feather Grass	5 Gallon	18" - 24" Ht.
15	$\oplus$	Calamagrostis acut. 'Overdam'	Overdam Feather Grass	5 Gallon	18" - 24" Ht.
49	+	Miscathus sinensis 'Gracillimus'	Gracillimus Maiden Grass	5 Gallon	24" - 3Ø" Ht.
42	0	Pennisetum alop. 'Hameln'	Hamein Dw. Fountain Grass	5 Gallon	15" - 18" Ht.
74	$\odot$	Pennisetum alop. 'Little Bunny'	Little Bunny Dw. Fountain Grass	5 Gallon	12" - 15" Ht.
<b>5</b> 3	0	Sesleria autumnalis	Autumn Moor Grass	2 Gallon	12" - 15" Ht.


\*\* Plant quantities are provided for convenience ONLY!! The contractor shall provide and install all plants either shown or noted on the plans.

XX-XX

REVISIONS


PROJECT/OWNER

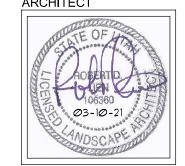


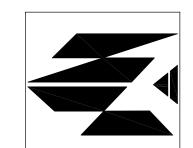

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SHEET NUMBER




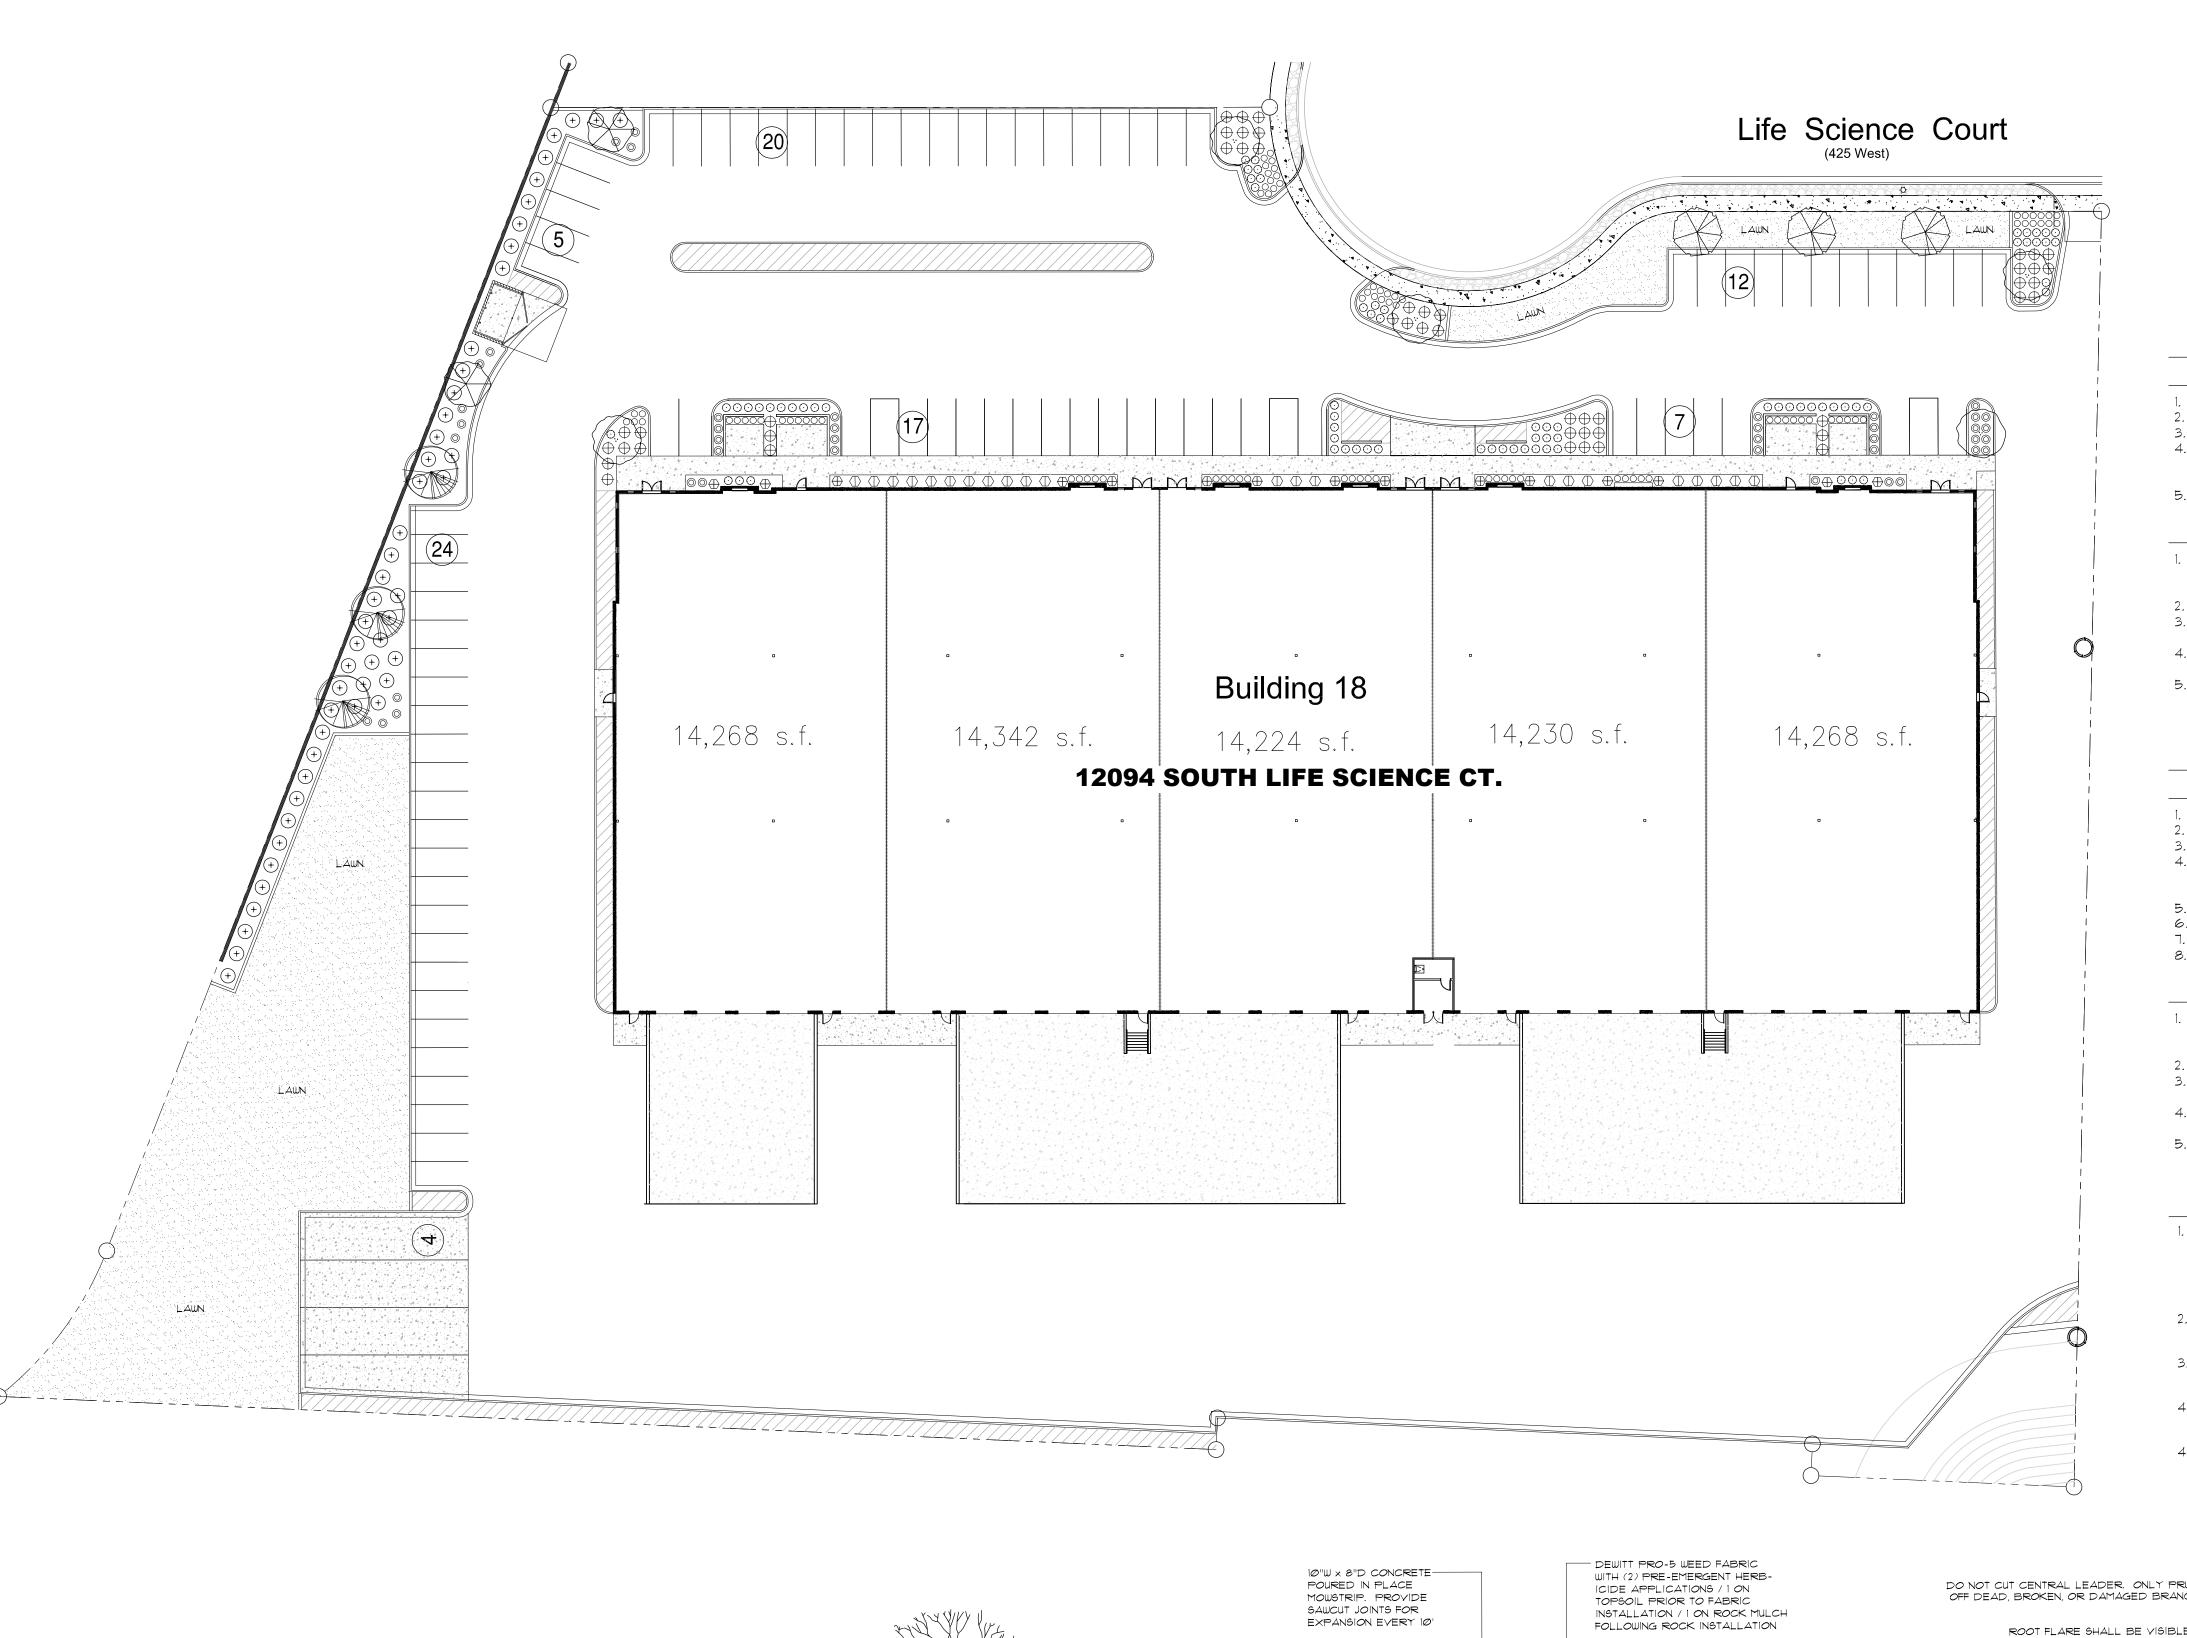
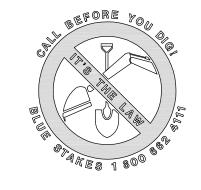
## Landscape Architect

RDL Design Company, Inc. 1020 East Yale Avenue Salt Lake City, Utah 84105

Phone: 801-647-3114 Email: rolldesign@comcast.net

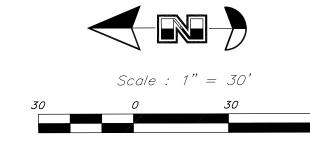

## Maintenance Requirements (Through Owner Final Acceptance)

### Landscape:

- Bi-weekly mowing of the lawn, including discarding of all grass materials off-site at no cost to Owner. Bi-weekly edging along all sidewaks and mowstrips to remove overgrowth of lawn onto concrete edges.
- Bi-weekly weeding of all planting beds as required to remove any weed growth that may occur.
   Fertilization of all lawn areas depending on time of final acceptance: (1) fertilization required.
- (1) Mid-April / Easter, (2) Early June / Memorial Day, (3) Mid Summer / July 4, (4) Early Fall / Labor Day,
- 5. The above items shall continue until such time as the project receives final acceptance by the Owner.

### Irrigation:

- 1. Initial Spring start-up of irrigation system at approximately April 15. This process shall be demonstrated with the Owner's general maintenance personnel staff present, so they are aware of what needs to be done following the one year maintenance period.
- 2. Bi-weekly walkthrough of planting beds to determine if all drip emitter devices are working properly.
  3. Adjusting auto-controller as required to adapt to changes in temperatures as the growing season pro-
- 4. Bi-weekly inspection or walkthrough of plant materials to see if there are any signs of irrigation components not working properly. All repairs or adjustments needed are to be a part of this process.
- 5. Initial Fall shut-down (Blow-Out) of irrigation system at approximatey October 15. This process shall be demonstrated with the Owner's general maintenance personnel staff present.

# Extended Maintenance Requirements (Through 1 Year Warranty)

### Landscape:

- Weekly mowing of the lawn, including discarding of all grass materials off-site at no cost to Owner. Weekly edging along all sidewaks and mowstrips to remove overgrowth of lawn onto concrete edges.
- 3. Weekly weeding of all planting beds as required to remove any weed growth that may occur.
- 4. Fertilization of all lawn areas according to the following scheduled times:

  (1) Mid-April / Easter, (2) Early June / Memorial Day, (3) Mid Summer / July 4, (4) Early Fall / Labor Day, (5) Late Fall / Halloween.
- 5. Pre-emergent herbicide application in early spring, to coincide with first fertilization. 6. General Spring clean-up of all planting beds and lawn areas to prepare for weekly maintenance.
- l. Aeration of all lawn areas with mechanical aerator.

### 8. Fall clean-up of all leaves and debris to prepare for winter months.


### Irrigation:

- 1. Spring start-up of irrigation system at approximately April 15. This process shall be demonstrated with the Owner's general maintenance personnel staff present, so they are aware of what needs to be done following the one year maintenance period.
- 2. Weekly walkthrough of planting beds to determine if all drip emitter devices are working properly. 3. Adjusting auto-controller as required to adapt to changes in temperatures as the growing season pro-
- 4. Monthly inspection or walkthrough of plant materials to see if there are any signs of irrigation components
- not working properly. All repairs or adjustments needed are to be a part of this process. Fall winterization (Blow-Out) of irrigation system at approximatey October 15. This process shall be demon

## Pre-construction Meeting / Progress Site Inspections

strated with the Owner's general maintenance personnel staff present.

- 1. A pre-construction meeting shall be held prior to the contractor beginning major work on the project. This will include Owner's property management and construction personnel, general contractor, landscape and/or irrigation contractor, as well as landscape architect. All questions or concerns to any project items shall be brought to attention at that time. Locations of required irrigation supply connections, controller locations and electrical supplys, general sub-grading elevations, project schedules and plant material availability and quality are typical items of main concern.
- 2. Following completion of sub-grading operations by the earthwork contractor, the landscape and/or irrigation contractor, general contractor and Owner's property management personnel shall review all sub-grade elevations, ensuring that the proper levels, prior to topsoil installation have been achieved.
- 3. The landscape contractor shall be responsible for the proper and accurate layout and placement of all plant materials as shown on the drawings. Any layout conflicts with existing site elements or changes in the site plan shall be brought to the attention of the landscape architect for resolution.
- 4. For trees and other materials purposely placed in alignment with parking stall layout, if parking striping has not been completed at the time of installation, the landscape contractor shall coordinate with the general contractor and striping sub-contractor to accurately measure parking stalls to ensure proper tree placements.
- 4. The landscape architect shall perform progress site inspections at times most critical during the course of construction. The landscape contractor, if needing any design clarification, shall provide a minimum 24 hour advanced notice in order to schedule on-site meetings with the landscape architect.

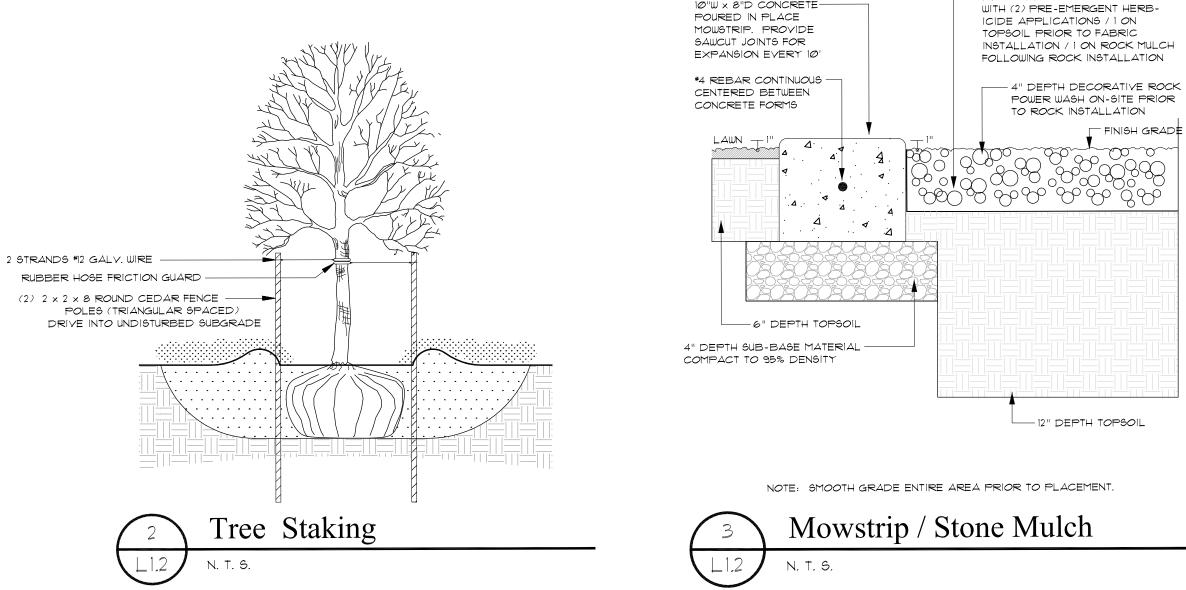

-BARK MULCH (4" DEPTH) IN

PLANTING PIT ONLY!! REMOVE

- DECORATIVE ROCK PRODUCT

BEYOND PLANTING PIT, AND

ROOT BALL (SET LEVEL ON GRADE)

TOPSOIL PLANTING MIX AS SPECIFIED (INSTALL AROUND ENTIRE ROOTBALL)


Shrub Planting

OVER WEED BARRIER FABRIC.

(4" MINIMUM DEPTH) INSTALLED

WEED BARRIER FABRIC PRIOR

TO BARK MULCH INSTALLATION.

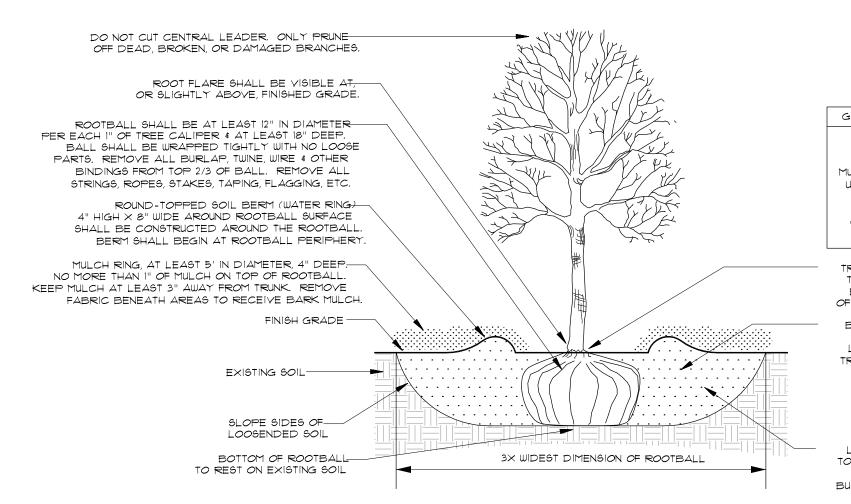

STAKING OF ALL TREES IS REQUIRED, UNLESS OTHERWISE DETERMINED BY THE OWNER. STAKES SHALL BE DRIVEN INTO GROUND OUTSIDE OF ROOTBALL. GUYING MATERIAL MUST BE WIDE & FLEXIBLE. HOSE & WIRE SHOULD NOT BE USED. TREES SHALL BE STAKED SO THAT THE TRUNK MAN MOVE NATURALLY IN THE WIND. ALL STAKING MATERIALS SHALL BE REMOVED BY INSTALLING CONTRACTOR WITHIN ONE YEAR'S TIME, OR IN COMPLIANCE WITH MAINTENANCE AND WARRANTY PERIOD DATES AS AGREED UPON.

TREE SHALL BE SET IN CENTER OF HOLE & STOOD UPRIGHT. TREE SHALL ONLY BE LIFTED BY WIRE BASKET. NEVER LIFT BY GRASPING TRUNK OR LIMBS OR BY ATTACHING ANY TYPE OF SLING OR CHOKER.

BACKFILL HOLE WITH NATIVE MATERIAL (50%) & IMPORT TOPSOIL (50%). LIGHTLY TAMP SOIL AROUND ROOTBALL IN 6" LIFTS TO BRACE TREE. COMPACT ONLY ENOUGH TO HOLD TREE IN PLACE, DO NOT OVER-COMPACT & NEVER USE MECHANICAL COMPACTION. ONCE PLANTING HOLE HAS BEEN BACKFILLED, WATER GENEROUSLY TO SOAK ENTIRE ROOTBALL & BACKFILL MATERIAL. BACKFILL MATERIAL MAY NEED TO BE ADDED AS SOIL SETTLES BELOW ROOT FLARE.


OOSENED SOIL, DIG & TURN THE SOIL TO REDUCE COMPACTION THE AREA & DEPTH SHOWN. TOPSOIL OR SOIL PEP MAY BACKFILL MATERIAL SHOULD COVER ROOT FLARE SLIGHTLY BUT SHALL NOT BE PILED AGAINST TRUNK.


Tree Planting / Lawn Area TREE PLANTING IN SHRUB AREAS TO BE SAME AS ABOVE DETAIL, WITH EXCEPTION THAT AREAS BEYOND BARK MULCH AREA SHALL RECEIVE WEED BARRIER FABRIC AND DECORATIVE ROCK AS SPECIFIED. XX-XX

REVISIONS

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PROJECT/OWNER




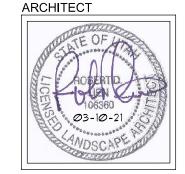


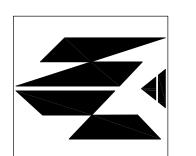
03-10-2021

SHEET NUMBER

# EXHIBIT G ELEVATIONS

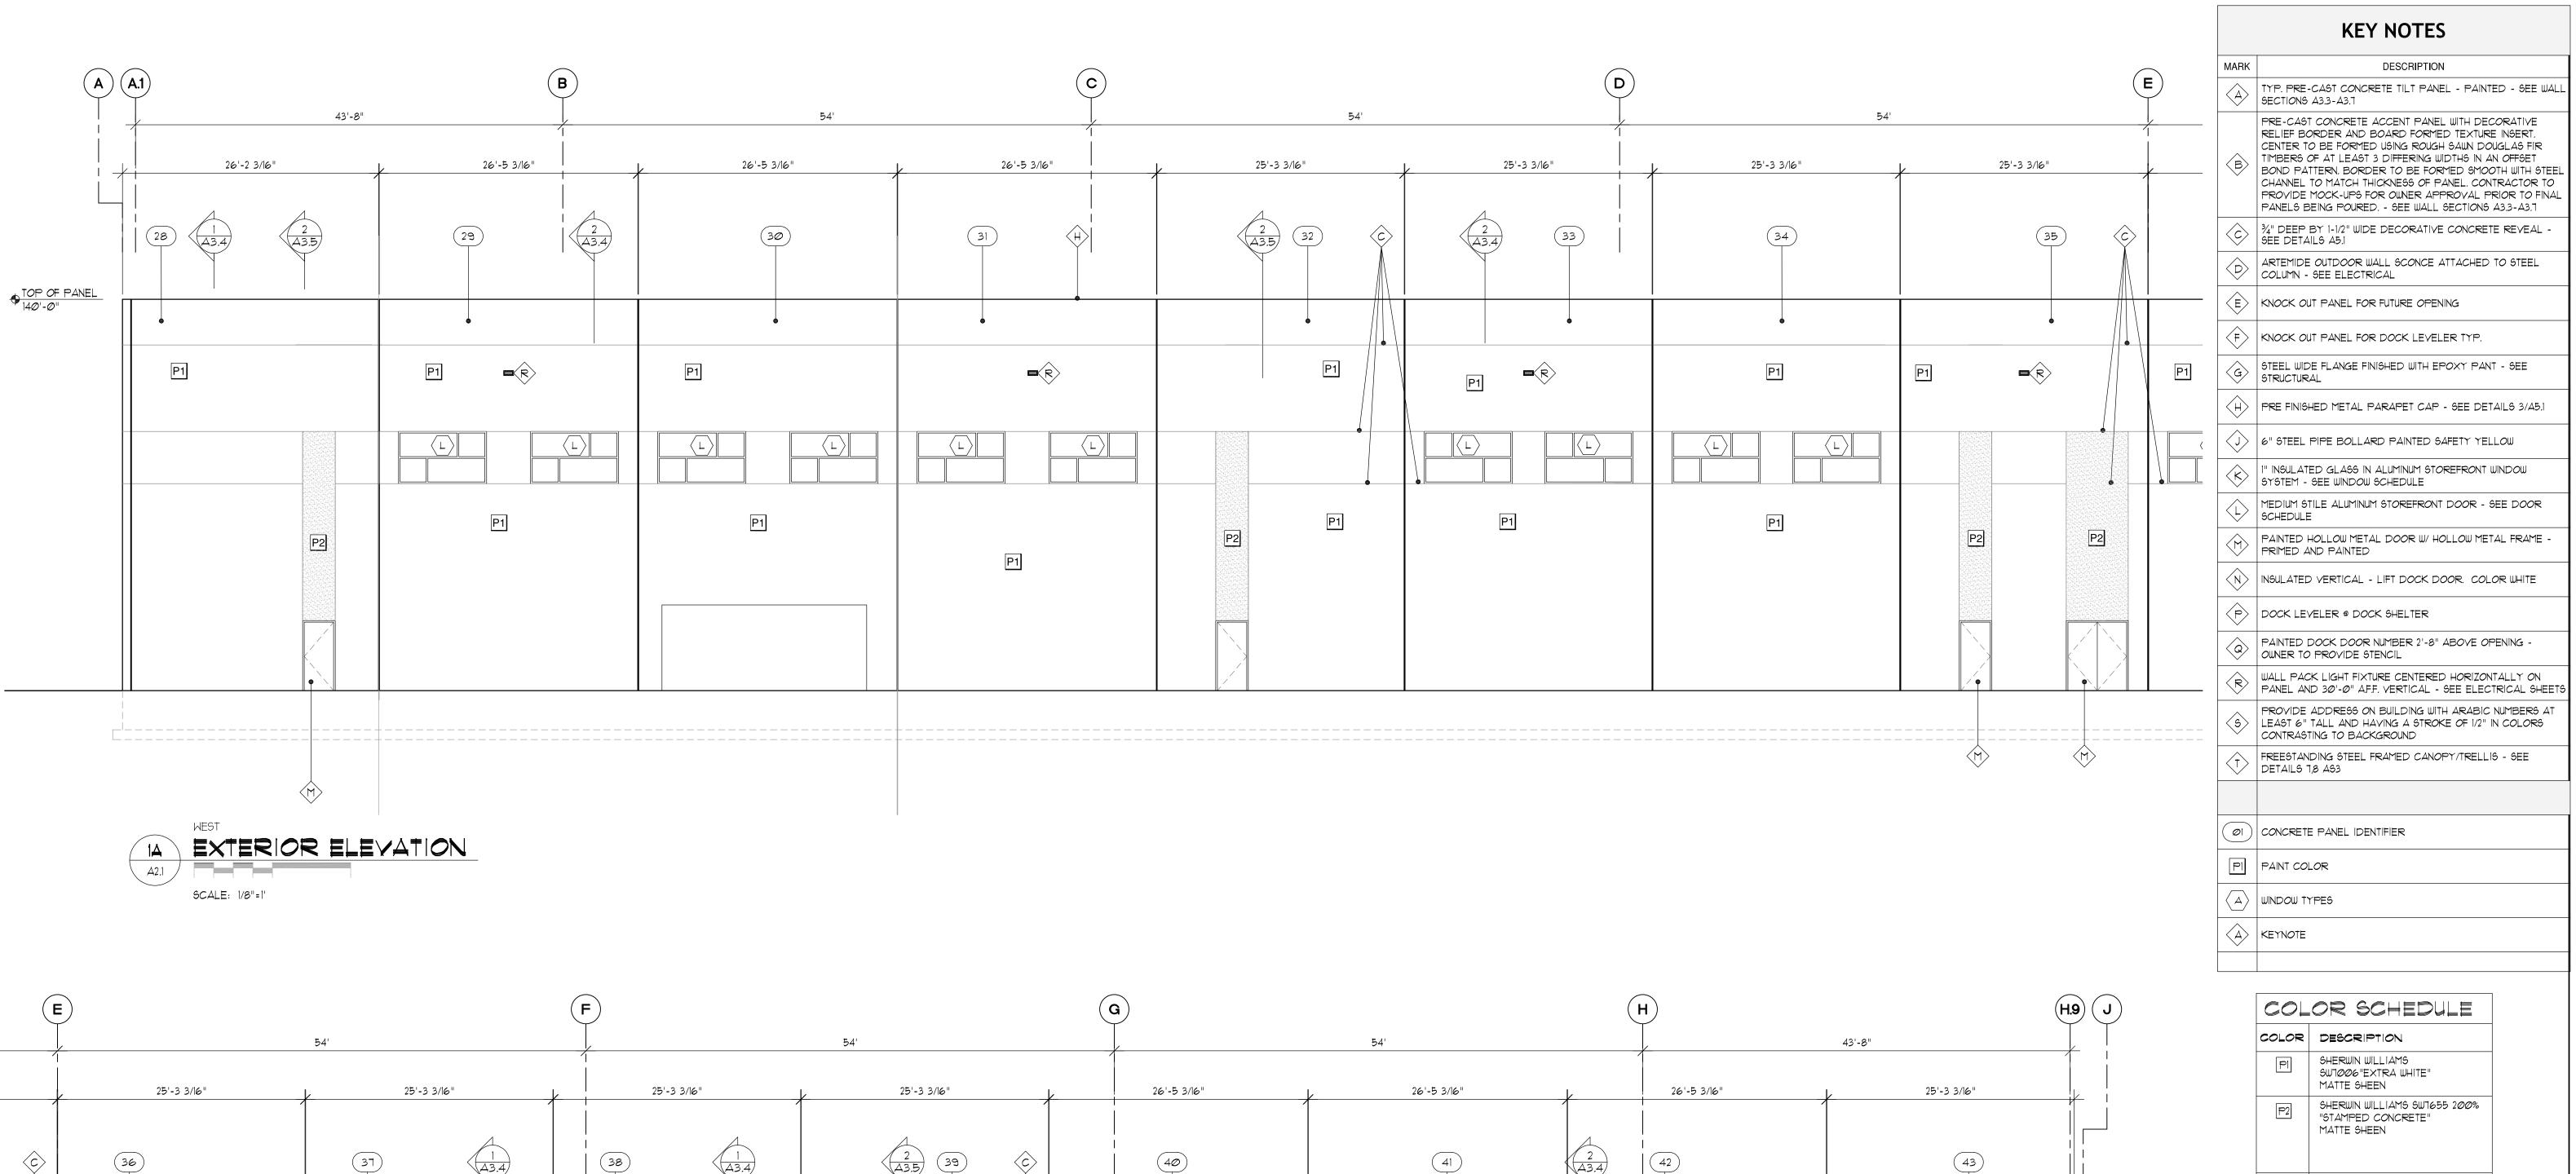

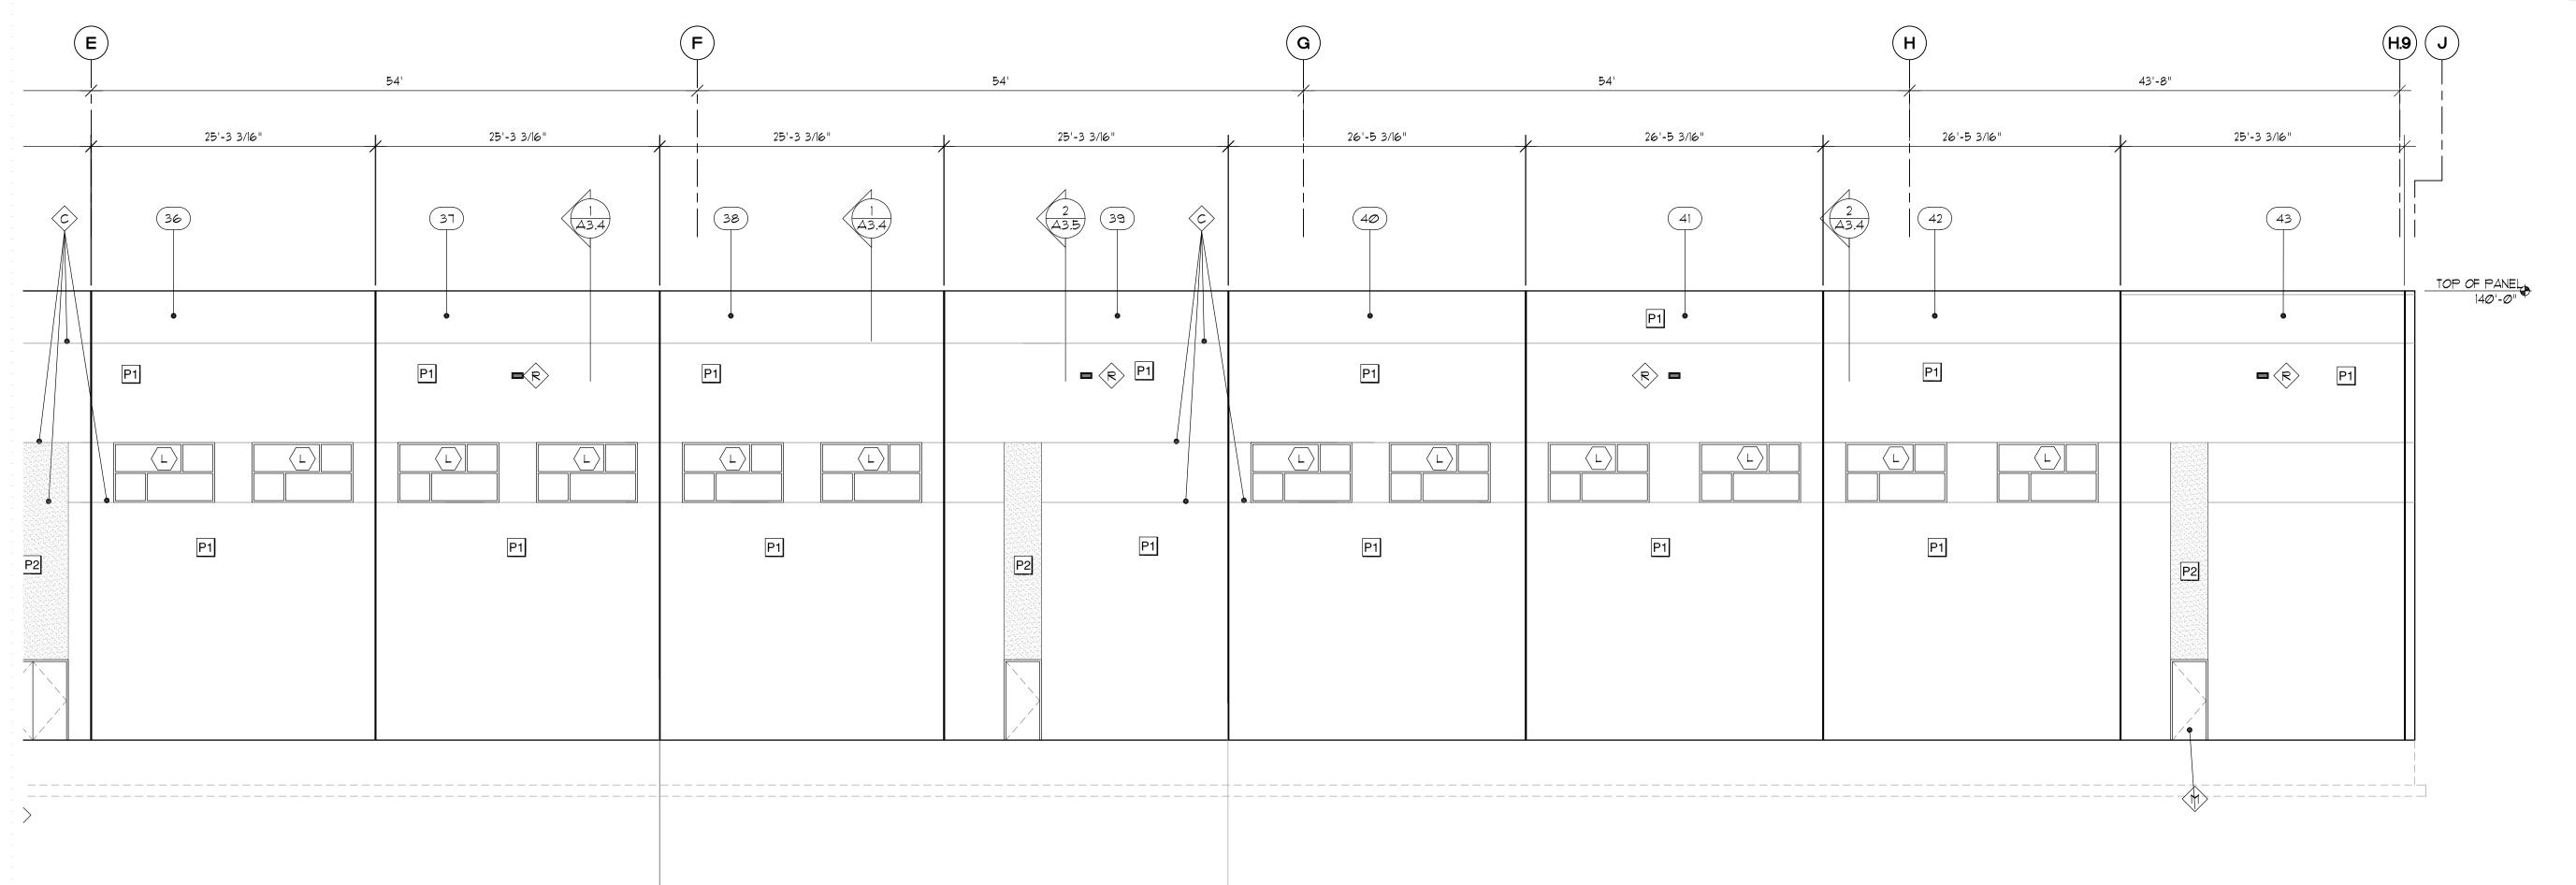

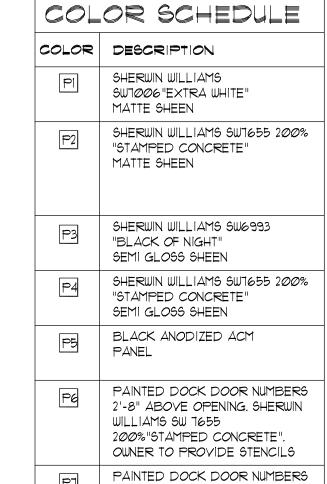

2'-8" ABOVE OPENING. SHERWIN WILLIAMS SW 7066 "EXTRA WHITE", OWNER TO PROVIDE

STENCILS

PROJECT NUMBER 20-42

REVISIONS

SHEET TITLE


PROJECT/OWNER

CT. LONE F BUILDIN 12158 SOI DRAPER, U PRICE LON 230 EAST

ARCHITECT

AYL

SOUTH 1300 WE JORDAN, UTAH

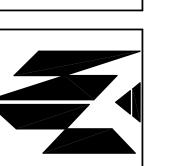



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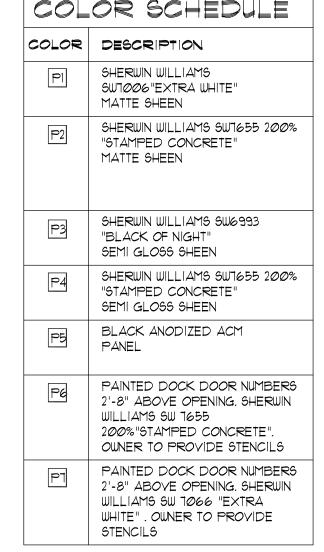
SHEET NUMBER

EXTERIOR ELEVATION


SCALE: 1/8"=1"



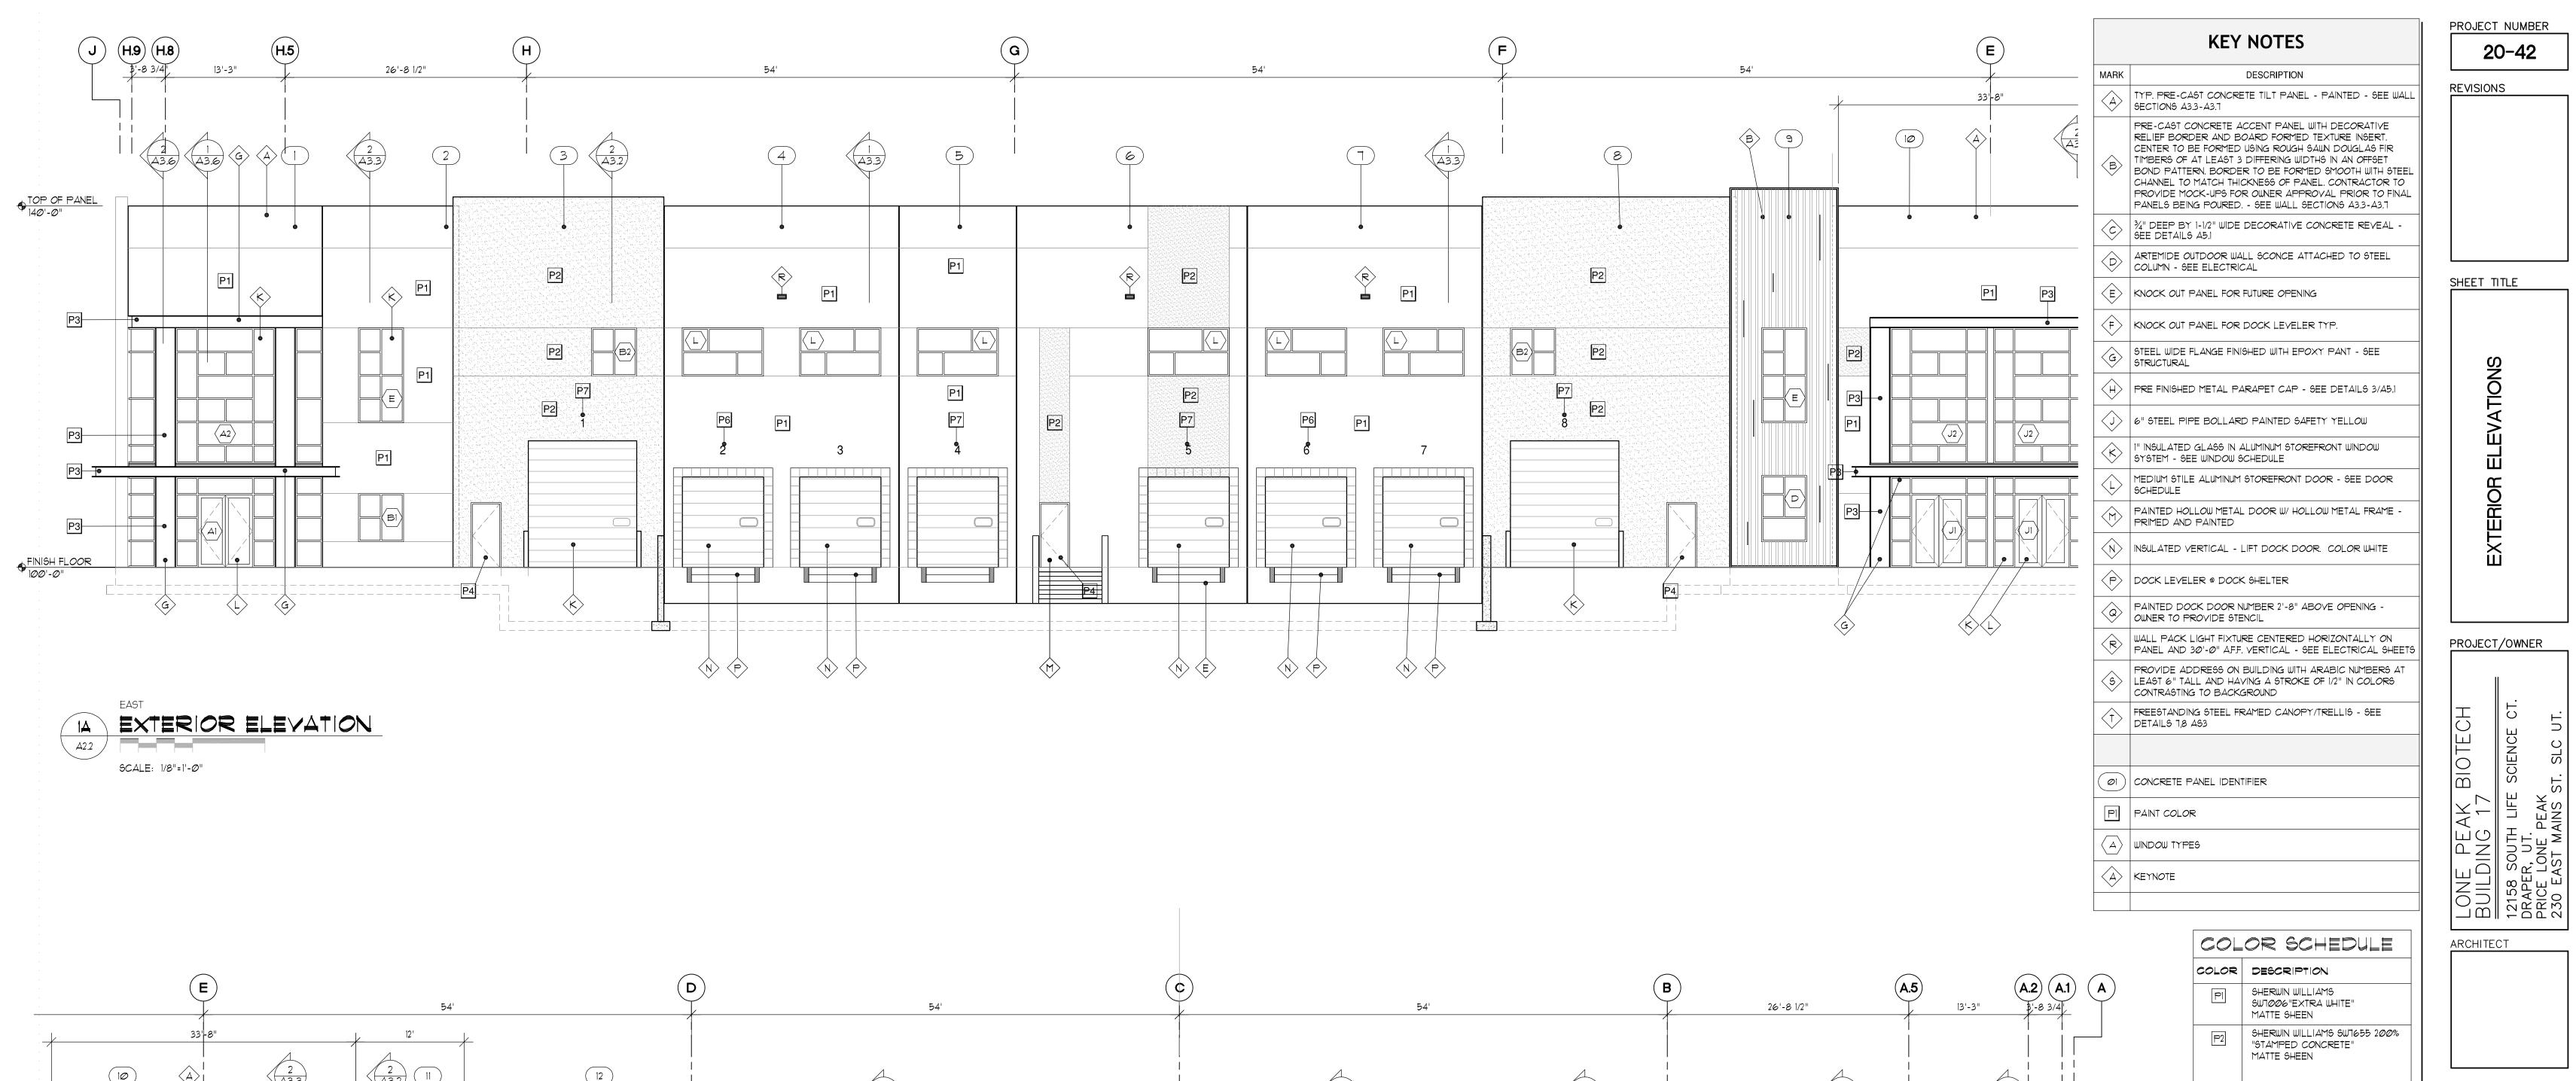

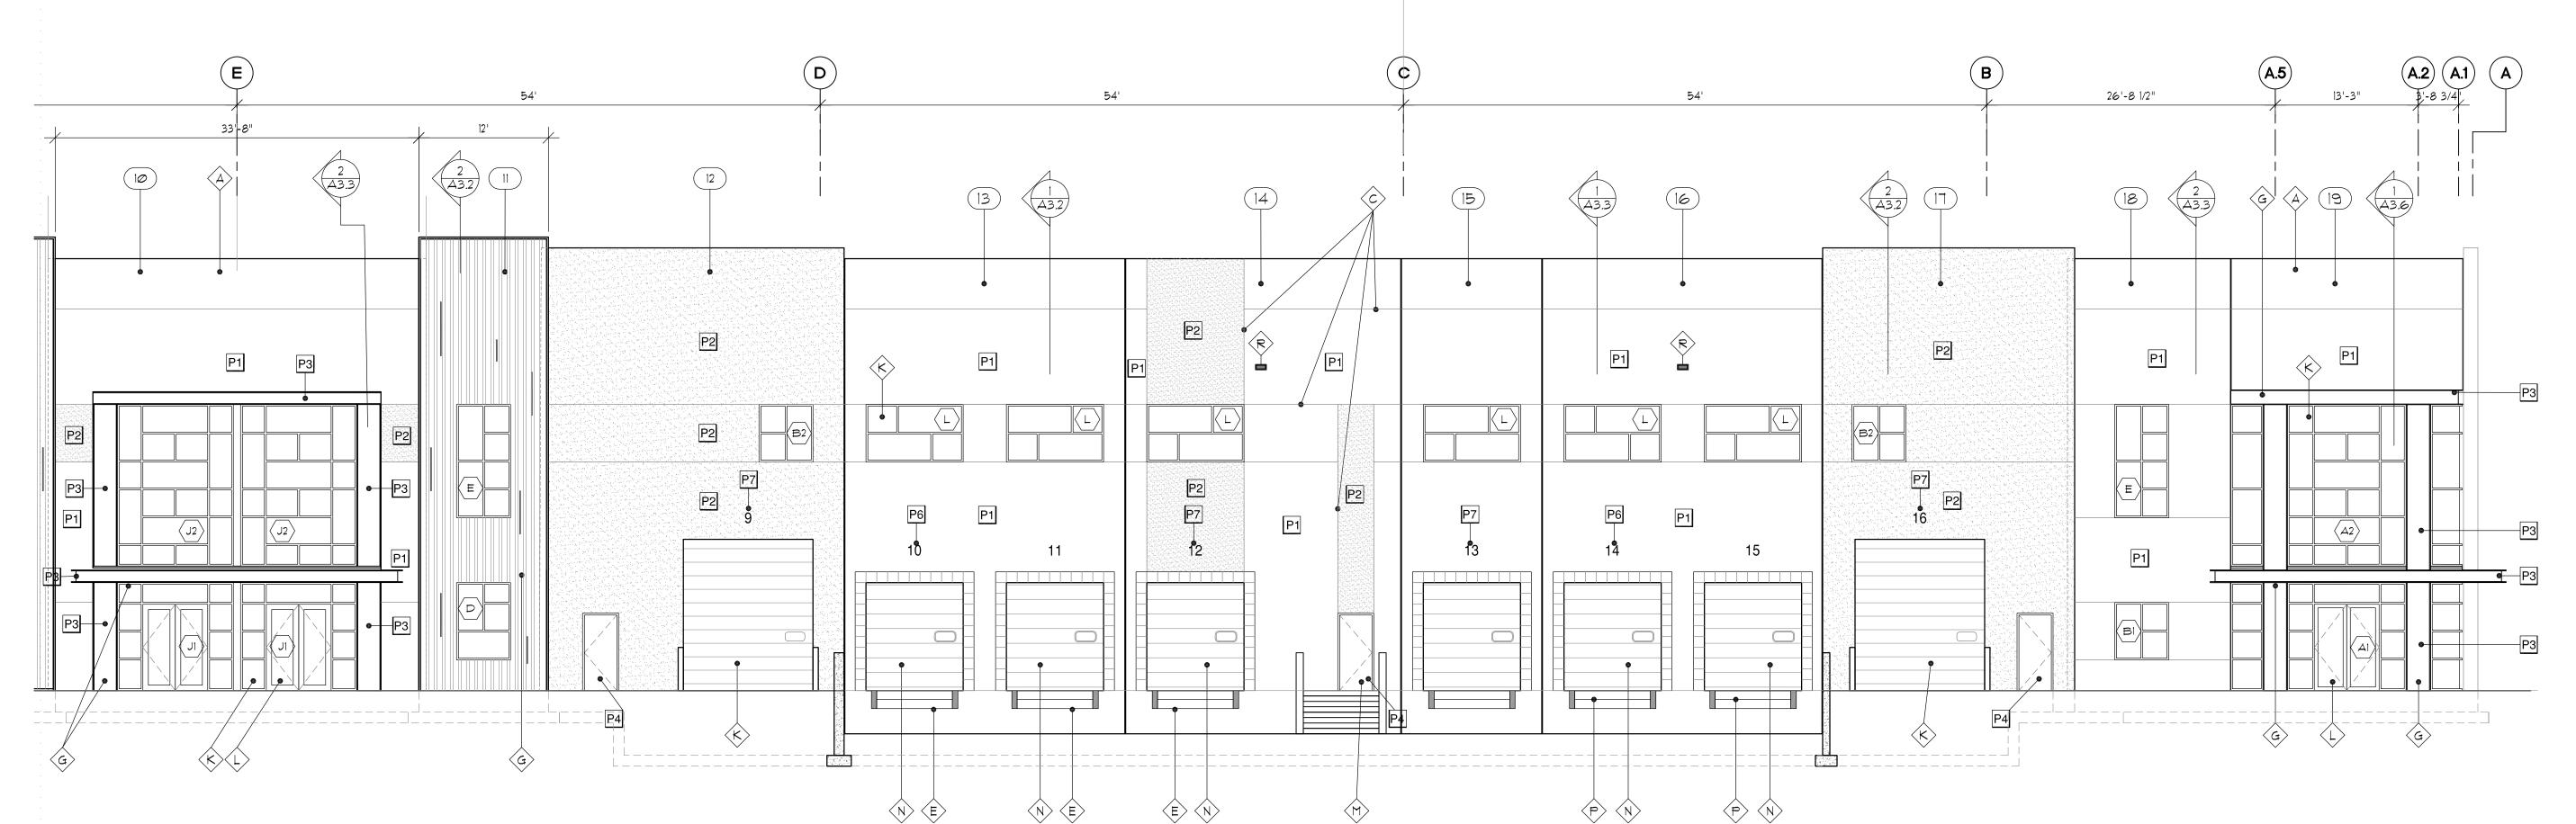

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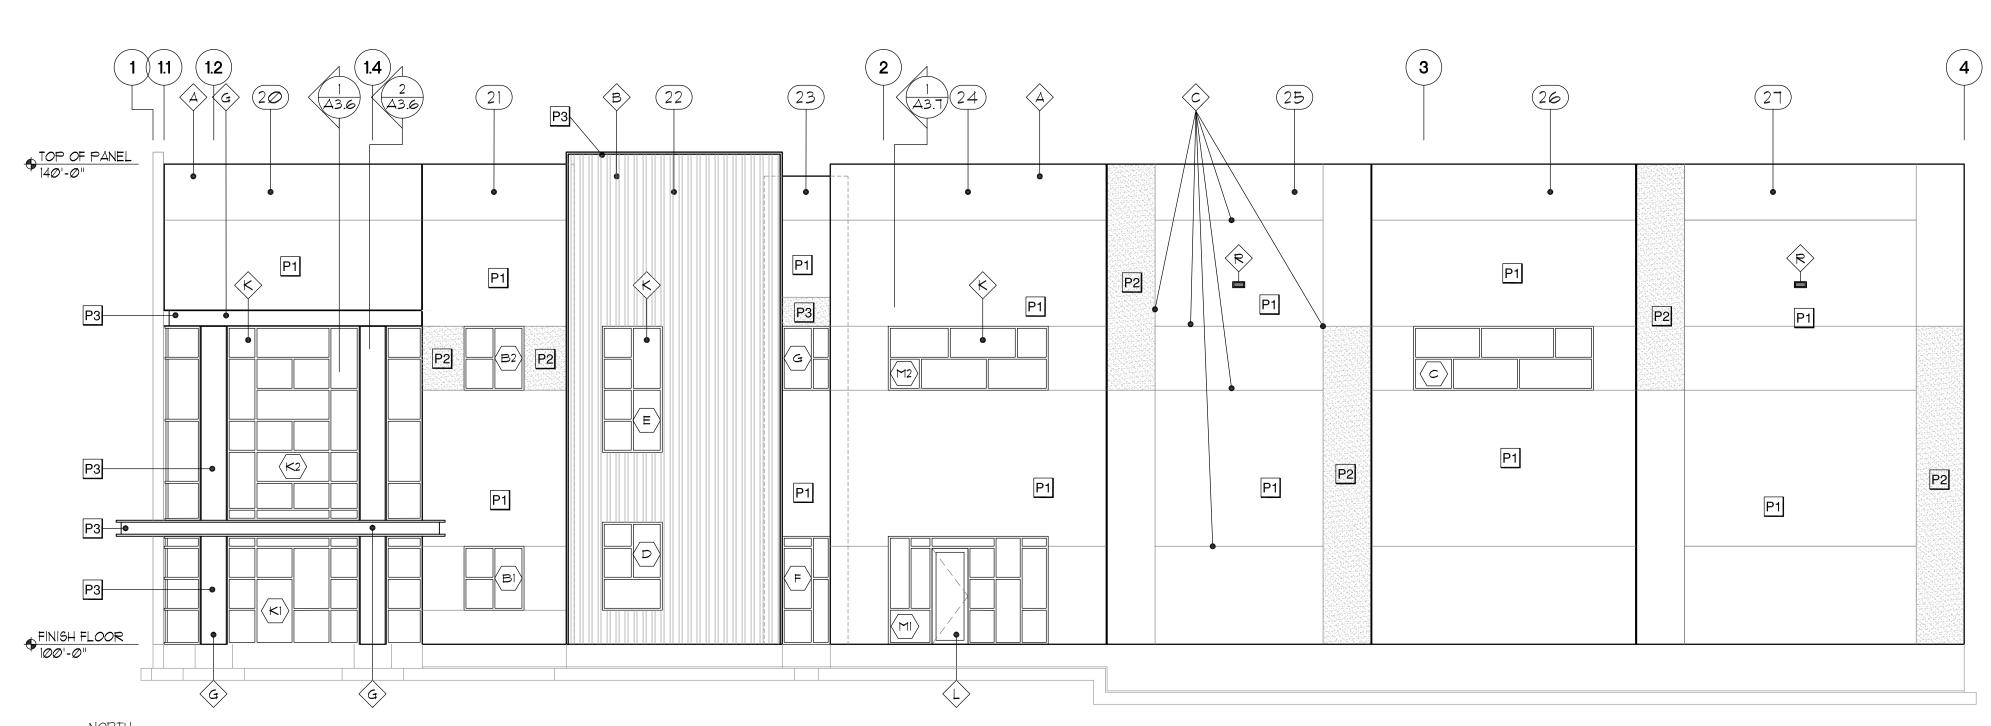

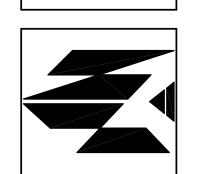
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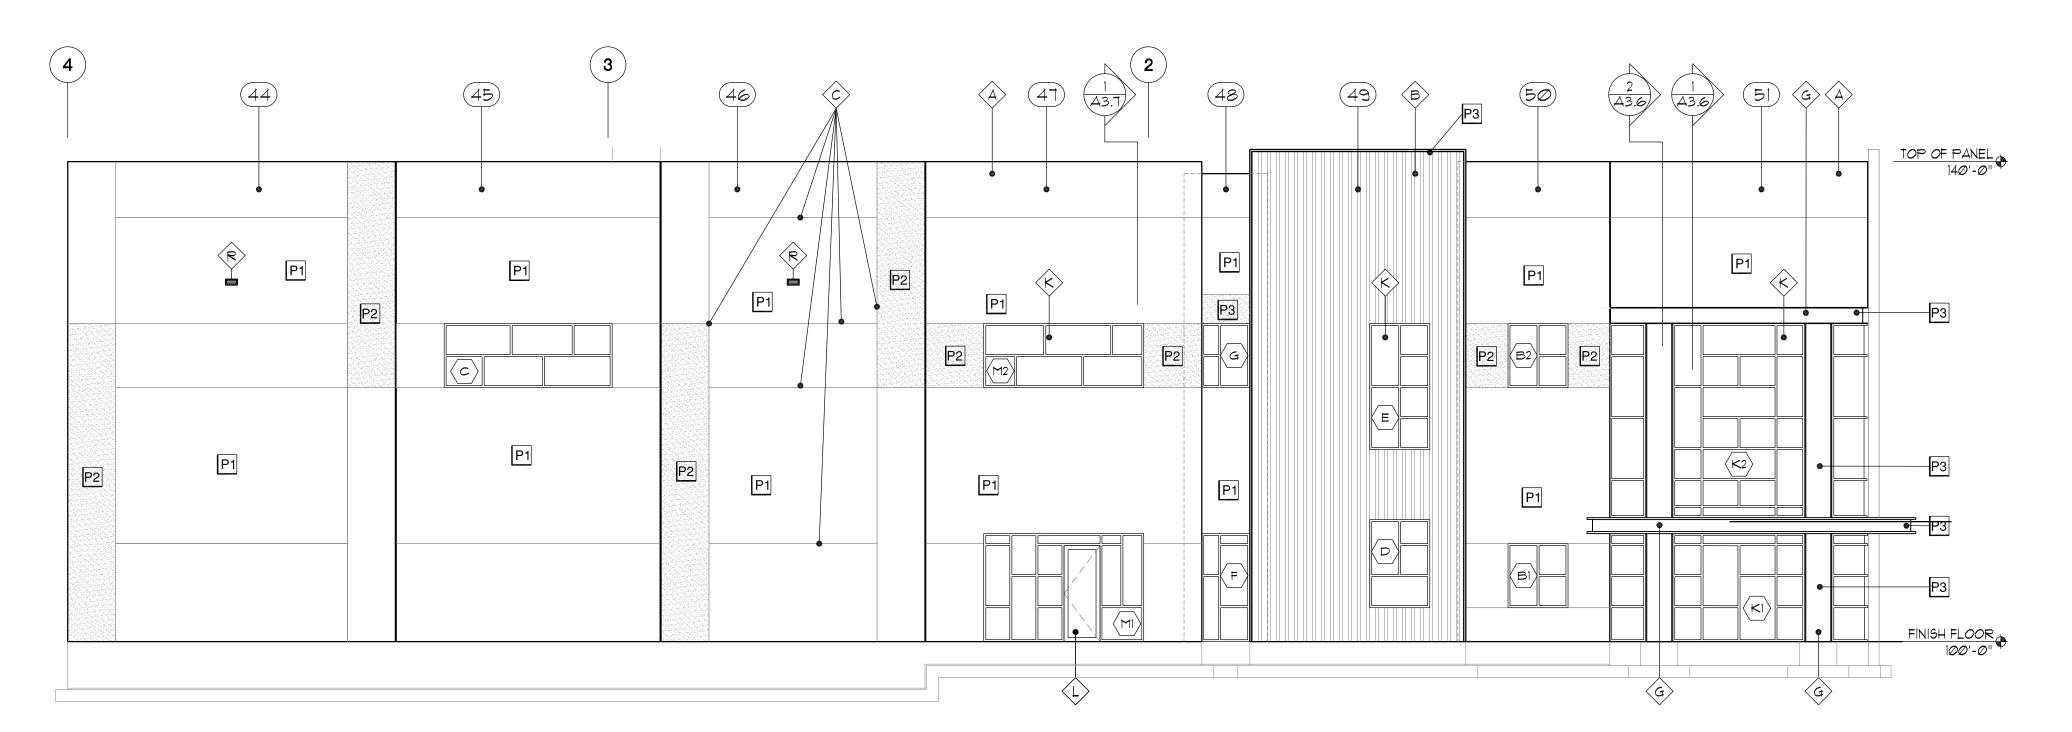
EXTERIOR ELEVATION A2.2

SCALE: 1/8"=1'-0"



EXTERIOR ELEVATION A2.3

SCALE: 1/8"=1'-0"



EXTERIOR ELEVATION **2**A2.3 SCALE: 1/8"=1'--0"

**KEY NOTES** DESCRIPTION TYP. PRE-CAST CONCRETE TILT PANEL - PAINTED - SEE WALL SECTIONS A3.3-A3.7 PRE-CAST CONCRETE ACCENT PANEL WITH DECORATIVE RELIEF BORDER AND BOARD FORMED TEXTURE INSERT. CENTER TO BE FORMED USING ROUGH SAWN DOUGLAS FIR TIMBERS OF AT LEAST 3 DIFFERING WIDTHS IN AN OFFSET BOND PATTERN. BORDER TO BE FORMED SMOOTH WITH STEEL CHANNEL TO MATCH THICKNESS OF PANEL. CONTRACTOR TO PROVIDE MOCK-UPS FOR OWNER APPROVAL PRIOR TO FINAL PANELS BEING POURED. - SEE WALL SECTIONS A3.3-A3.7 34" DEEP BY 1-1/2" WIDE DECORATIVE CONCRETE REVEAL - SEE DETAILS A5.1 ARTEMIDE OUTDOOR WALL SCONCE ATTACHED TO STEEL COLUMN - SEE ELECTRICAL (E) KNOCK OUT PANEL FOR FUTURE OPENING (F) KNOCK OUT PANEL FOR DOCK LEVELER TYP.

G STEEL WIDE FLANGE FINISHED WITH EPOXY PANT - SEE STRUCTURAL

(H) PRE FINISHED METAL PARAPET CAP - SEE DETAILS 3/A5.

I" INSULATED GLASS IN ALUMINUM STOREFRONT WINDOW

(J) 6" STEEL PIPE BOLLARD PAINTED SAFETY YELLOW

1" INSULATED GLASS IN ALGI III SYSTEM - SEE WINDOW SCHEDULE MEDIUM STILE ALUMINUM STOREFRONT DOOR - SEE DOOR

SCHEDULE PAINTED HOLLOW METAL DOOR W/ HOLLOW METAL FRAME -

(N) INSULATED VERTICAL - LIFT DOCK DOOR. COLOR WHITE

P DOCK LEVELER @ DOCK SHELTER

PRIMED AND PAINTED

PAINTED DOCK DOOR NUMBER 2'-8" ABOVE OPENING - OWNER TO PROVIDE STENCIL

WALL PACK LIGHT FIXTURE CENTERED HORIZONTALL . S. PANEL AND 30'-0" AFF. VERTICAL - SEE ELECTRICAL SHEETS

PROVIDE ADDRESS ON BUILDING WITH ARABIC NUMBERS AT LEAST 6" TALL AND HAVING A STROKE OF 1/2" IN COLORS

CONTRASTING TO BACKGROUND FREESTANDING STEEL FRAMED CANOPY/TRELLIS - SEE

DETAILS 7,8 AS3

( ØI ) CONCRETE PANEL IDENTIFIER

PI PAINT COLOR

| A | WINDOW TYPES

(A) KEYNOTE

COLOR SCHEDULE					
COLOR	DESCRIPTION				
P.	SHERWIN WILLIAMS SW1006"EXTRA WHITE" MATTE SHEEN				
P2	SHERWIN WILLIAMS SW1655 200% "STAMPED CONCRETE" MATTE SHEEN				
<b>P</b> 3	SHERWIN WILLIAMS SW6993 "BLACK OF NIGHT" SEMI GLOSS SHEEN				
P4	SHERWIN WILLIAMS SW1655 200% "STAMPED CONCRETE" SEMI GLOSS SHEEN				
P5	BLACK ANODIZED ACM PANEL				
Pé	PAINTED DOCK DOOR NUMBERS 2'-8" ABOVE OPENING, SHERWIN WILLIAMS SW 1655 200%"STAMPED CONCRETE". OWNER TO PROVIDE STENCILS				
PT	PAINTED DOCK DOOR NUMBERS 2'-8" ABOVE OPENING. SHERWIN WILLIAMS SW 1066 "EXTRA WHITE" . OWNER TO PROVIDE STENCILS				

PROJECT NUMBER

REVISIONS

SHEET TITLE

BUILDING 17 RIOR ELEVATIONS


PROJECT/OWNER

CT. SCIENCE LONE BUILI 12158 DRAPER PRICE 230 EA


ARCHITECT

NAYLOR

SOUTH 1300 WEST JORDAN, UTAH 84 NCHOLS

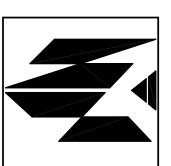

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PROJECT NUMBER 20-42

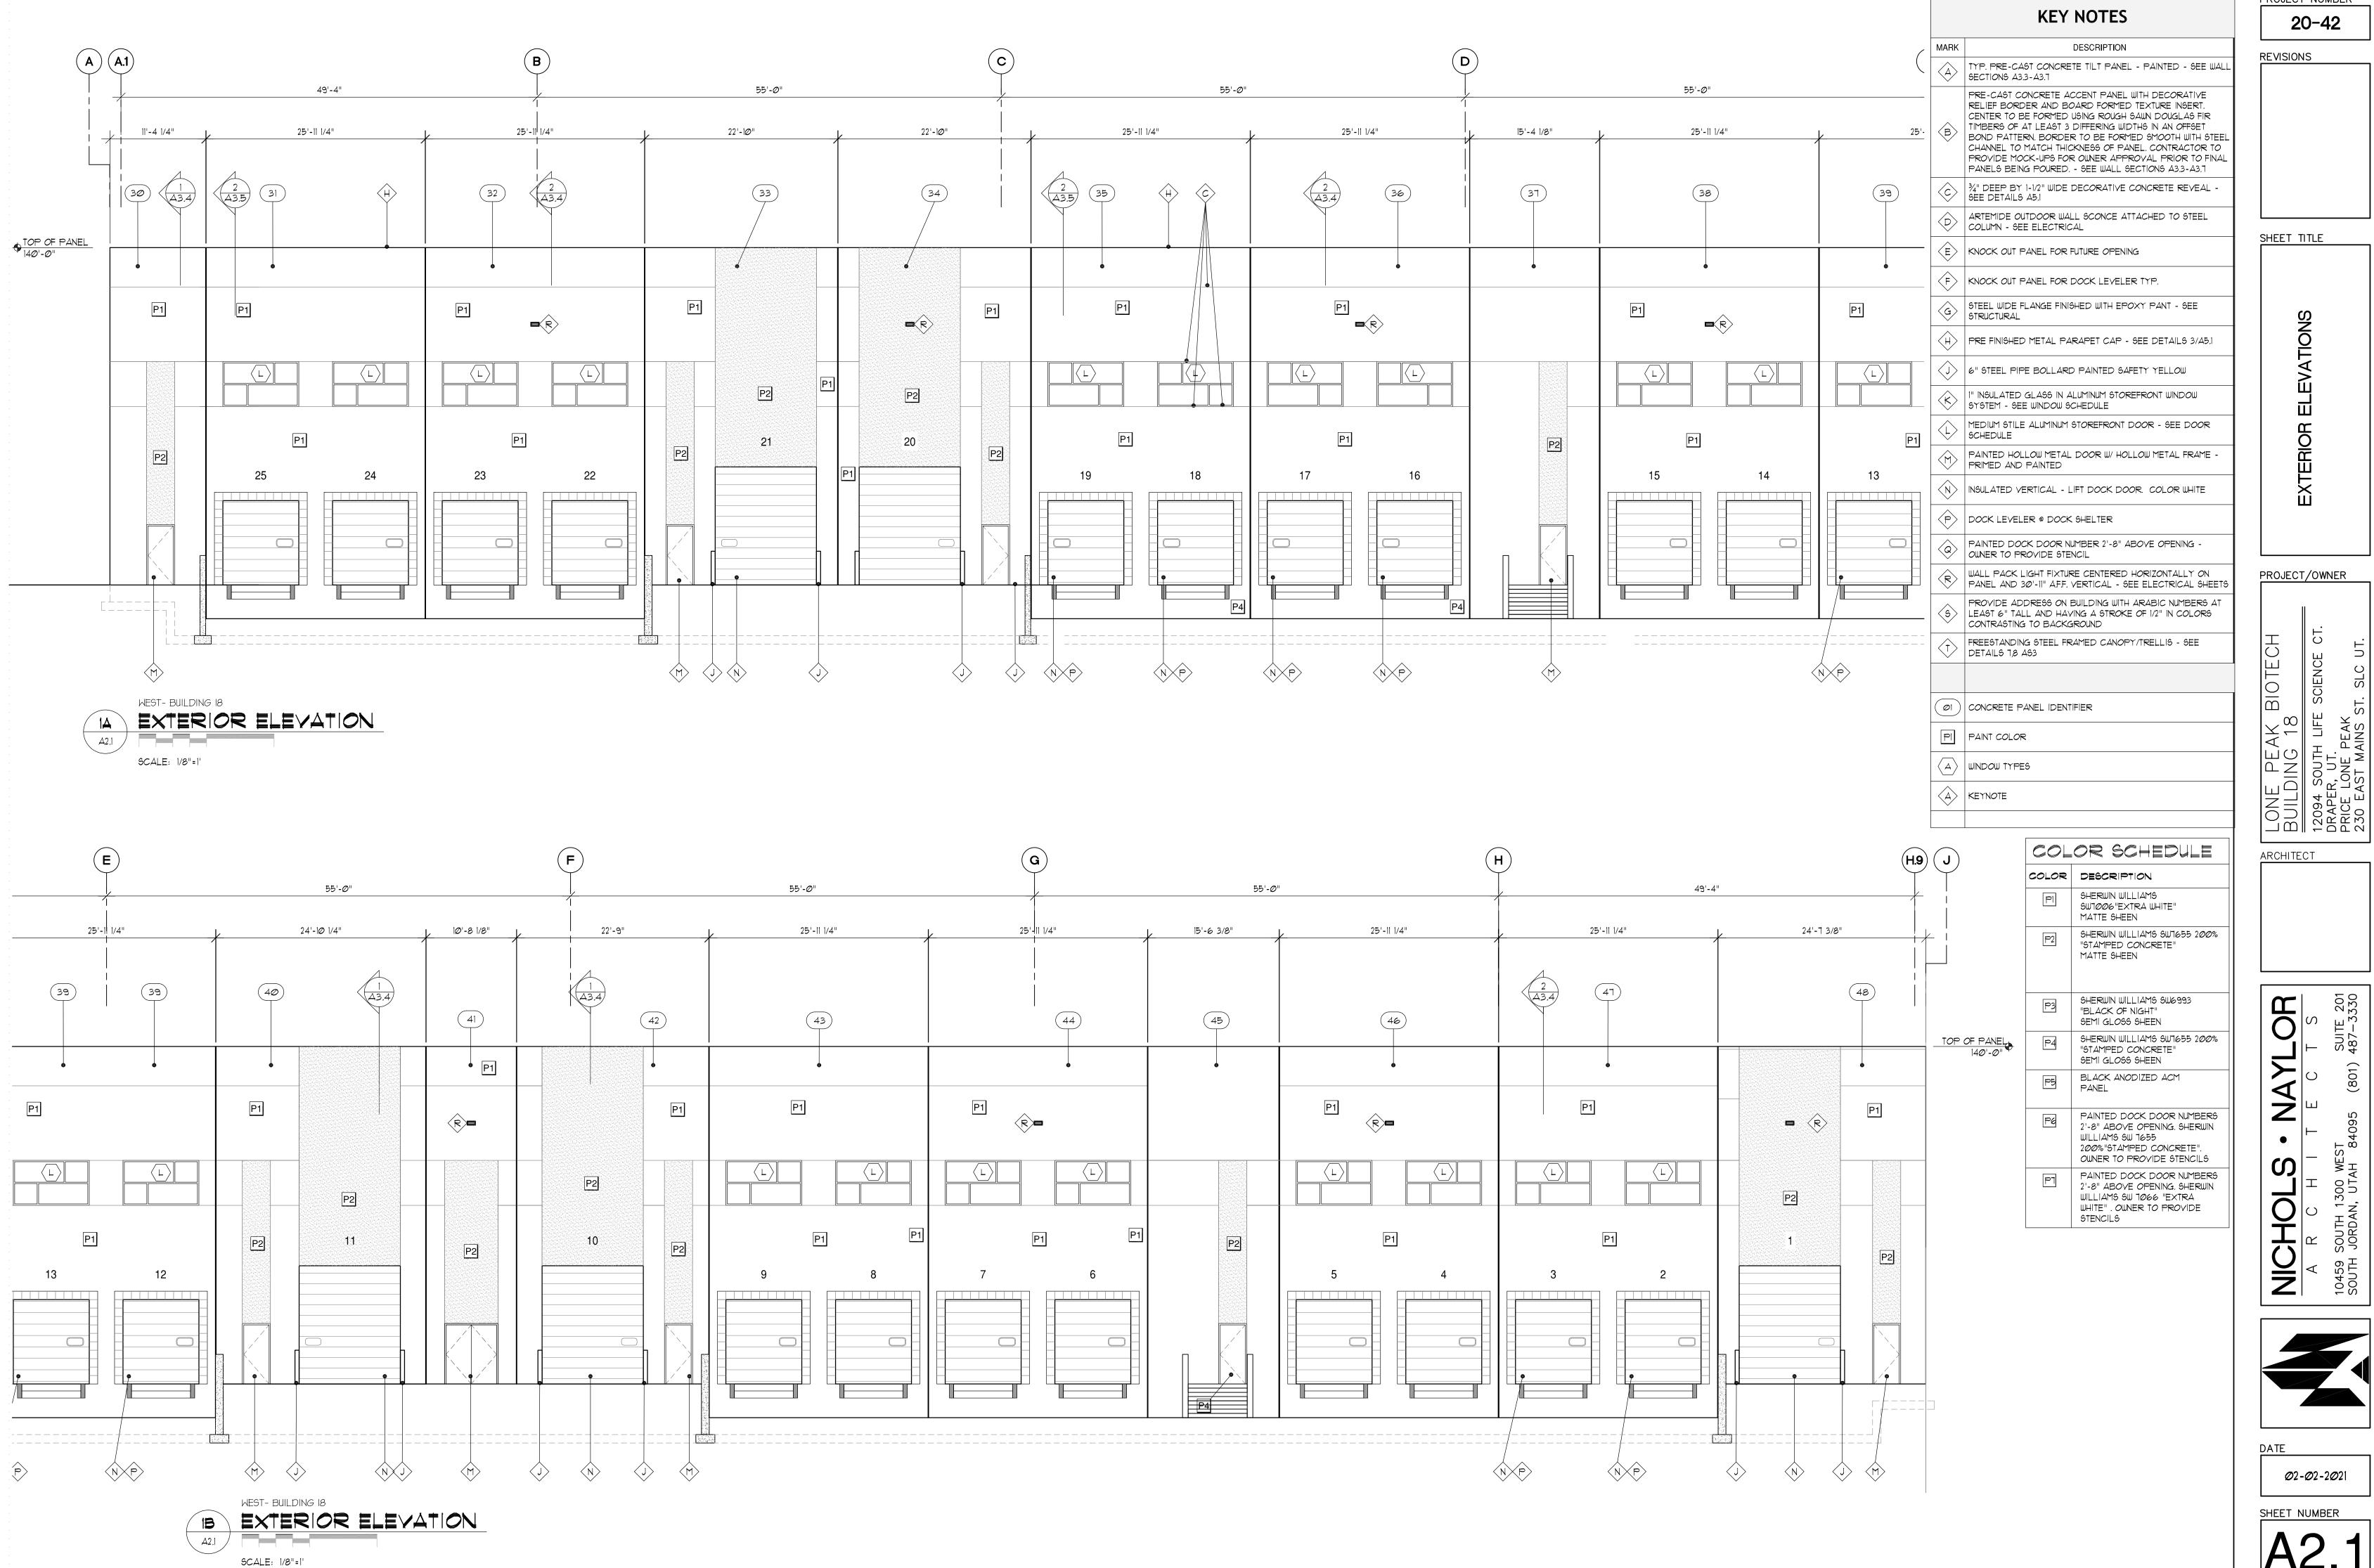SHEET TITLE

PROJECT/OWNER

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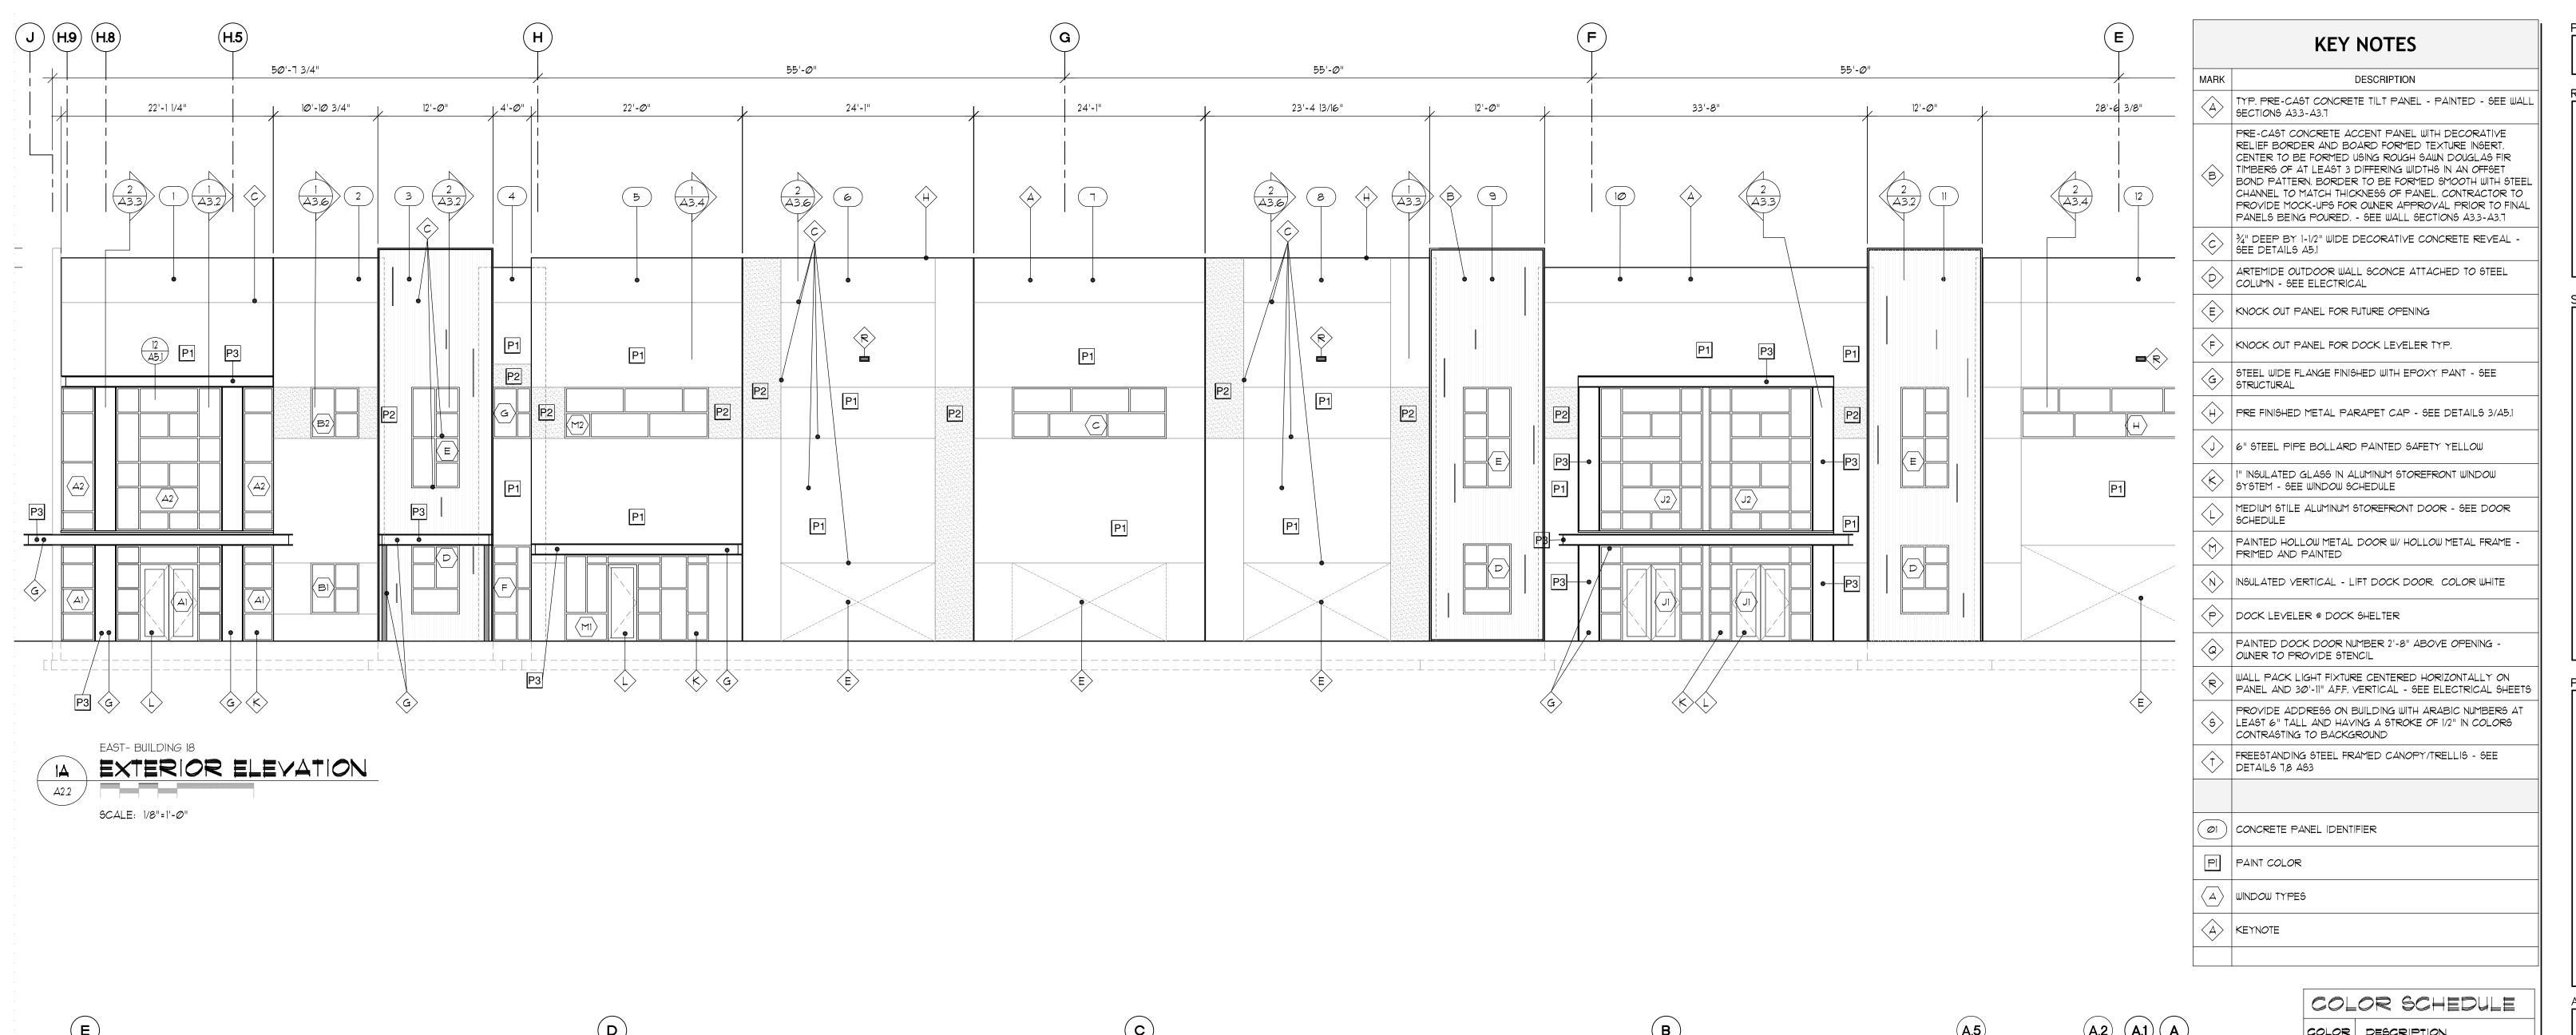
AYL


SOUTH 1300 JORDAN, UTA



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SHEET NUMBER



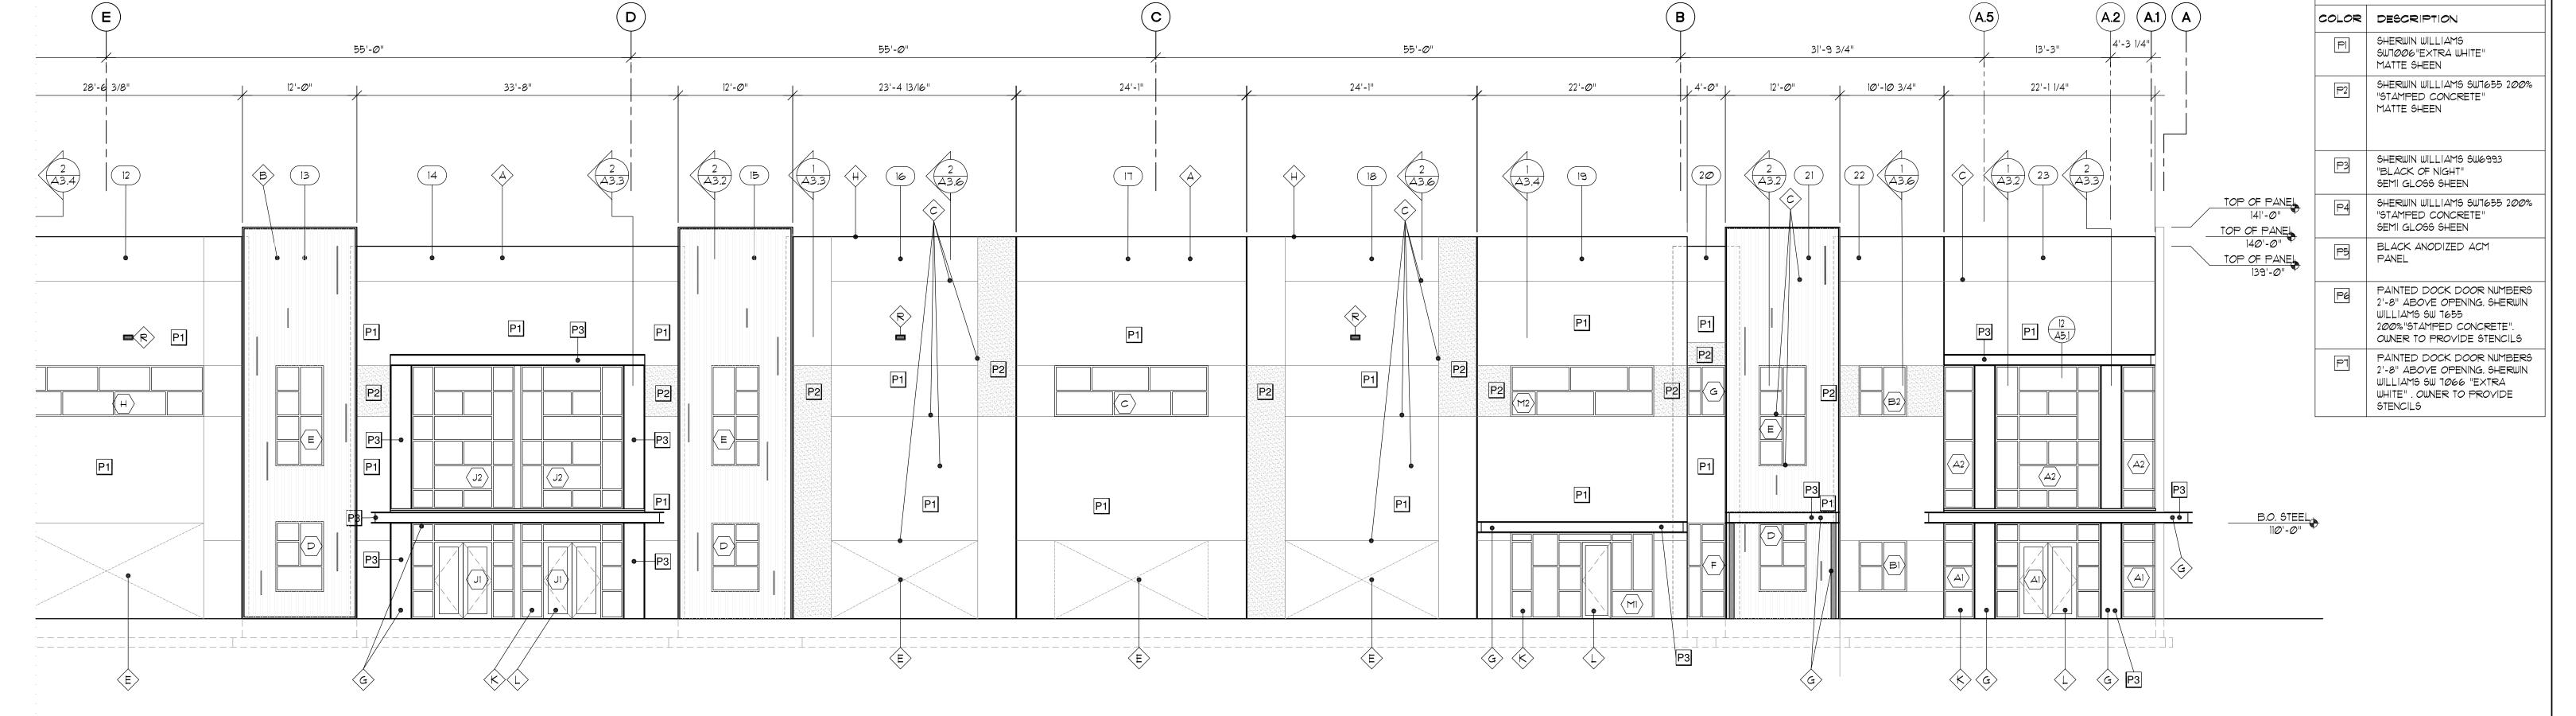

EAST- BUILDING 18 EXTERIOR ELEVATION A2.2 SCALE: 1/8"=1'-0"

PROJECT NUMBER

REVISIONS

SHEET TITLE

PROJECT/OWNER


CT. LONE PE BUILDINC 12094 SOUT DRAPER, UT PRICE LONE 230 EAST M

ARCHITECT


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MARK	DESCRIPTION			
(A)	TYP. PRE-CAST CONCRETE TILT PANEL - PAINTED - SEE WALL SECTIONS A3.3-A3.7			
B	PRE-CAST CONCRETE ACCENT PANEL WITH DECORATIVE RELIEF BORDER AND BOARD FORMED TEXTURE INSERT. CENTER TO BE FORMED USING ROUGH SAWN DOUGLAS FIR TIMBERS OF AT LEAST 3 DIFFERING WIDTHS IN AN OFFSET BOND PATTERN. BORDER TO BE FORMED SMOOTH WITH STEEL CHANNEL TO MATCH THICKNESS OF PANEL. CONTRACTOR TO PROVIDE MOCK-UPS FOR OWNER APPROVAL PRIOR TO FINAL PANELS BEING POURED SEE WALL SECTIONS A3.3-A3.1			
⟨c⟩	34" DEEP BY 1-1/2" WIDE DECORATIVE CONCRETE REVEAL - SEE DETAILS A5.1			
(D)	ARTEMIDE OUTDOOR WALL SCONCE ATTACHED TO STEEL COLUMN - SEE ELECTRICAL			
(E)	KNOCK OUT PANEL FOR FUTURE OPENING			
(F)	KNOCK OUT PANEL FOR DOCK LEVELER TYP.			
G	STEEL WIDE FLANGE FINISHED WITH EPOXY PANT - SEE STRUCTURAL			
(H)	PRE FINISHED METAL PARAPET CAP - SEE DETAILS 3/A5.1			
$\langle$	6" STEEL PIPE BOLLARD PAINTED SAFETY YELLOW			
⟨ <b>K</b> ⟩	I" INSULATED GLASS IN ALUMINUM STOREFRONT WINDOW SYSTEM - SEE WINDOW SCHEDULE			
⟨L⟩	MEDIUM STILE ALUMINUM STOREFRONT DOOR - SEE DOOR SCHEDULE			
$\langle \gamma \rangle$	PAINTED HOLLOW METAL DOOR W/ HOLLOW METAL FRAME - PRIMED AND PAINTED			
$\langle N \rangle$	INSULATED VERTICAL - LIFT DOCK DOOR. COLOR WHITE			
P	DOCK LEVELER @ DOCK SHELTER			
<u>Q</u>	PAINTED DOCK DOOR NUMBER 2'-8" ABOVE OPENING - OWNER TO PROVIDE STENCIL			
(R)	WALL PACK LIGHT FIXTURE CENTERED HORIZONTALLY ON PANEL AND 30'-11" AFF. VERTICAL - SEE ELECTRICAL SHEETS			
<u>\$</u>	PROVIDE ADDRESS ON BUILDING WITH ARABIC NUMBERS AT LEAST 6" TALL AND HAVING A STROKE OF 1/2" IN COLORS CONTRASTING TO BACKGROUND			
$\langle \uparrow \rangle$	FREESTANDING STEEL FRAMED CANOPY/TRELLIS - SEE DETAILS 1,8 AS3			
<b>Ø</b> 1	CONCRETE PANEL IDENTIFIER			
Pl	PAINT COLOR			
$\langle A \rangle$	WINDOW TYPES			
$\langle A \rangle$	KEYNOTE			

COLOR SCHEDULE				
COLOR	DESCRIPTION			
Pl	SHERWIN WILLIAMS SW1006"EXTRA WHITE" MATTE SHEEN			
P2	SHERWIN WILLIAMS SW7655 200% "STAMPED CONCRETE" MATTE SHEEN			
<b>P</b> 3	SHERWIN WILLIAMS SW6993 "BLACK OF NIGHT" SEMI GLOSS SHEEN			
P4	SHERWIN WILLIAMS SW1655 200% "STAMPED CONCRETE" SEMI GLOSS SHEEN			
P5	BLACK ANODIZED ACM PANEL			
Pd	PAINTED DOCK DOOR NUMBERS 2'-8" ABOVE OPENING. SHERWIN WILLIAMS SW 1655 200%"STAMPED CONCRETE". OWNER TO PROVIDE STENCILS			
F	PAINTED DOCK DOOR NUMBERS 2'-8" ABOVE OPENING, SHERWIN WILLIAMS SW 7066 "EXTRA WHITE", OWNER TO PROVIDE STENCILS			

PROJECT NUMBER
20-42

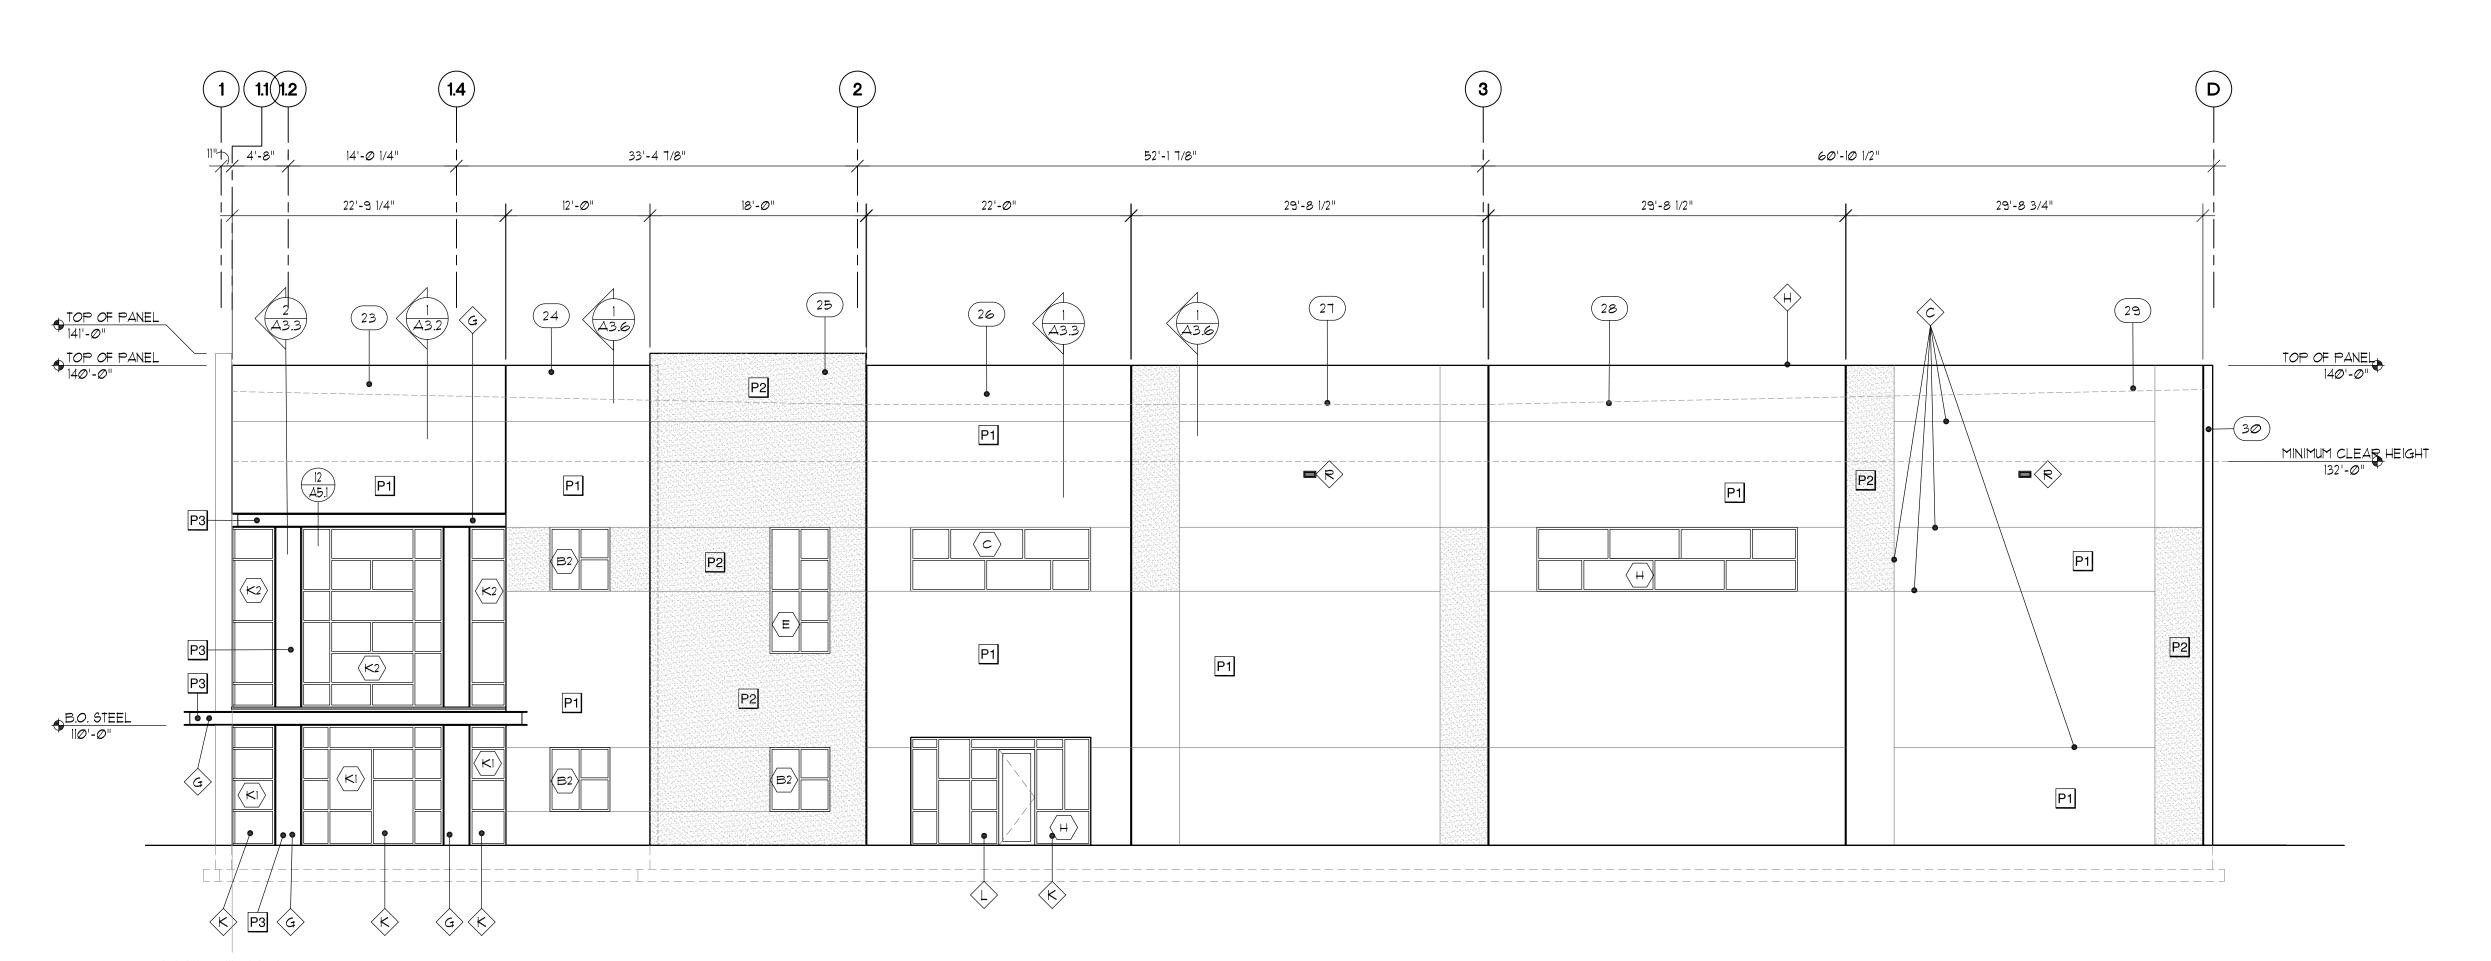REVISIONS

SHEET TITLE

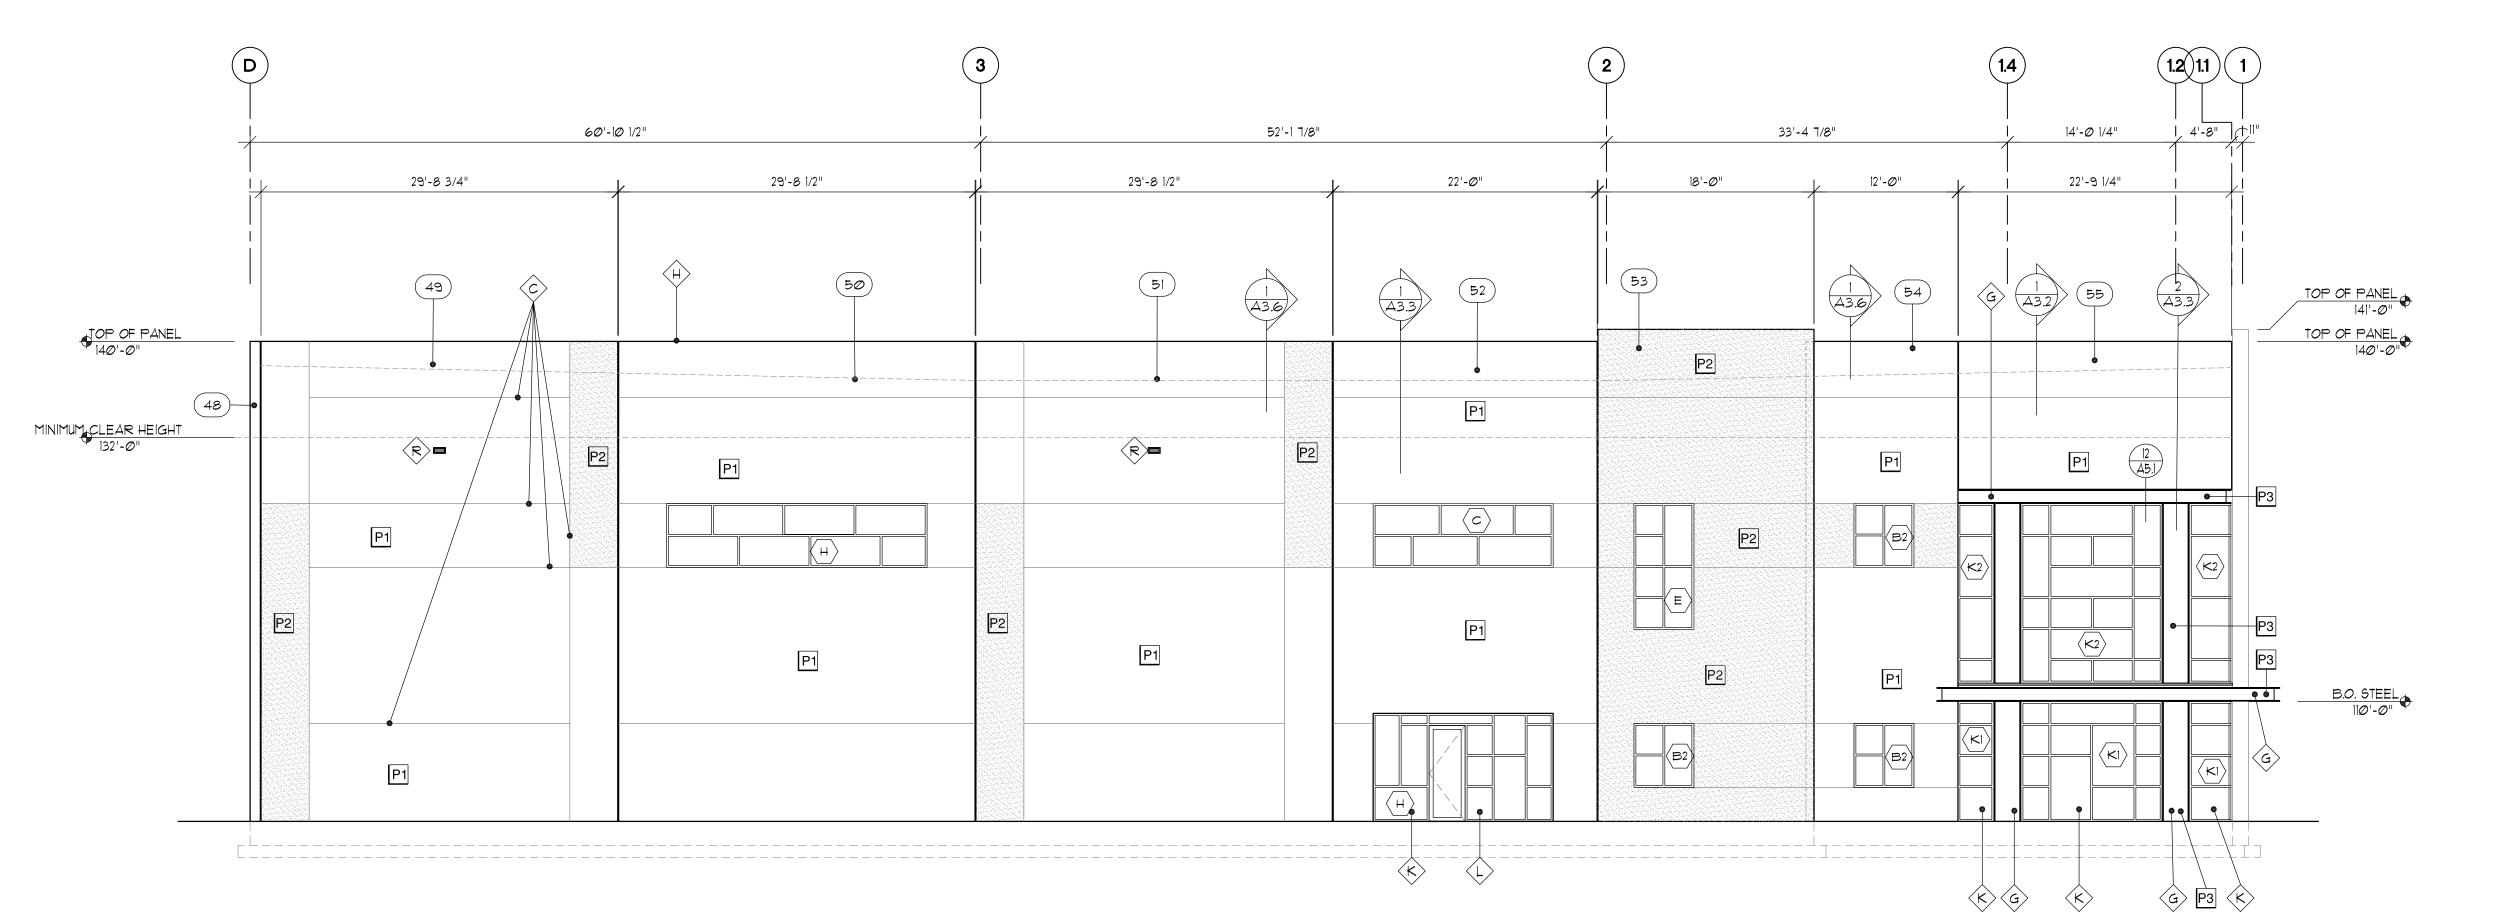EXTERIOR ELEVATIONS

PROJECT/OWNER

LONE PEAK BIOTECH
BUILDING 18
12094 SOUTH LIFE SCIENCE CT.
DRAPER, UT.
PRICE LONE PEAK
230 EAST MAINS ST. SLC UT.

A DOUITEOT

ARCHITECT


NAYLOR

E C T S

SUITE 201
35 (801) 487-3330

NCHOLS · NA
A R C H I T E

10459 SOUTH 1300 WEST
SOUTH JORDAN, UTAH 84095 (

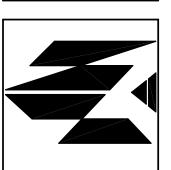

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